

**Undertaking given under Section 9.5 of the
Environmental Planning and Assessment Act
1979 (NSW) by:**

Arash Tavakoli

Undertaking given under Section 9.5 of the *Environmental Planning and Assessment Act 1979* (NSW) by Arash Tavakoli

1. Person giving the Undertaking

- 1.1 This undertaking is given to the Planning Secretary of the Department of Planning, Housing and Infrastructure ('**Planning Secretary**') by Mr Arash Tavakoli, for the purposes of section 9.5 of the *Environmental Planning and Assessment Act 1979* (NSW) ('**EP&A Act**').
- 1.2 Mr Tavakoli is the Sole Director and Shareholder of Neil Street Co Pty Ltd (ACN 134 507 350) which was previously named Landmark Construction Group Australia Pty Ltd – (ACN 134 507 350) ('**Company**').
- 1.3 Mr Tavakoli's contact details are:
- (a) Address: 4-6 Bayview Hill Road, Rose Bay
 - (b) Telephone: (02) 9231 8679
 - (c) Email: Legal@landmarkgr.com

- 1.4 Mr Tavakoli's wife is the registered proprietor of 4-6 Bayview Hill Road, Rose Bay NSW (Lot 10 and 11 in DP 88161) ('**Residence**'). Mr Tavakoli has an equitable interest in the Residence and considers himself to be its owner.

2. Background

Background to the Development

- 2.1 Woollahra Municipal Council ('**Council**') alleges that between 11 May 2021 and 8 September 2022 certain works were carried out on land owned by Council, comprising an unformed area of Bayview Hill Road, Rose Bay, bounded by:
- (a) The southern boundary of 8 Bayview Hill Road, Rose Bay;
 - (b) The mean low water mark of Port Jackson;
 - (c) The northern boundary of the Residence; and
 - (d) The western edge of the public lookout adjacent to the Residence.
('**Land**')

- 2.2 The following works have been carried out on the Land:

- (a) **Wall 1** – Construction of a retaining wall adjacent to the southern boundary of the Land to the rear of the dwelling and landscaped area of the Residence:
 - (i) measuring approximately between 4600mm and 1600mm in height, descending down the slope of the Land from east to west and then turning 90 degrees to the north to traverse the Land from south to north at an approximate height of 1650mm; and
 - (ii) constructed of 300mm sandstone blocks with a sediment medium behind.
- (b) **Walls 2 and 3** – Construction of a retaining wall/sea wall which returned east to west between the north western edge of Wall 1 and Port Jackson:
 - (i) measuring approximately 1600mm to 1500mm high; and
 - (ii) constructed with irregular shaped sandstone pieces with a sediment medium behind. ('**Wall 2**')
and
(iii) Construction of a sea wall running north to south from the western return of Wall 2, adjacent to the mean high watermark of Port Jackson:
 - (iv) measuring approximately between 2900mm and 3400mm above the natural rock shelf of Port Jackson; and

- (v) constructed with irregular shaped sandstone pieces with a sediment medium behind. ('**Wall 3**')
 - (c) **Work 1** - Construction of two storm water pits located adjacent to the top of Wall 1 in the area where Wall 1 travels from south to north.
 - (d) **Work 2** - Construction of two storm water pipes travelling from the pits located adjacent to the top of Wall 1 (i.e. Work 1) through to Wall 3.
 - (e) **Earthworks** – Carrying out of “earthworks” in the area encompassed by Wall 2 to the north, Wall 3 to the west, the northern boundary of the Residence, and Wall 1 to the east, by filling the Land to raise the level of the Land by approximately 3000mm-3500mm above Port Jackson, and generally at the same level as the rear landscaped area of the Residence.
 (collectively, '**the Works**')
- 2.3 The Works were carried out on the Land by the Company. Mr Tavakoli aided, abetted, counselled and procured the Company to carry out the Works (as set out at [2.5] below), and, without Council consent, is presently occupying the Land.
- The Alleged Contraventions**
- 2.4 The Council alleges that Mr Tavakoli aided, abetted, counselled, or procured the Company to commit an offence against the *EP&A Act*, being the carrying out of the Works listed above on the Land, without obtaining development consent under an environmental planning instrument ('**Alleged Conduct**').
- 2.5 The Alleged Conduct on the part of Mr Tavakoli contravened the *EP&A Act*, as:
- (a) Section 4.2(1)(a) states that if an environmental planning instrument provides that specified development may not be carried out except with development consent, a person must not carry out development on land to which the provision applies unless such a consent has been obtained and is in force;
 - (b) The Works were carried out without development consent contrary to the provisions under section 4.2(1)(a) of the *EP&A Act*, and Mr Tavakoli was aware of the need for consent for the Works; and
 - (c) The aiding, abetting, counselling or procuring of the Works, which Mr Tavakoli intentionally did, gives rise to an offence pursuant to section 9.50(3A)(a) of the *EP&A Act*.
 ('**Alleged Contraventions**')
- 2.6 Mr Tavakoli acknowledges that undertaking development without first obtaining consent constitutes a contravention of section 4.2 or section 9.50 of the *EP&A Act*, or both.
- 2.7 Mr Tavakoli offered this Undertaking to Council.
- Response to the Alleged Contraventions**
- 2.8 Mr Tavakoli acknowledges the community impacts which arise from breaches of the *EP&A Act*, including harm to the regulatory scheme which establishes an orderly method for the obtaining of planning approvals prior to carrying out development.
- 2.9 Mr Tavakoli acknowledges that development carried out without consent does not undergo prior impacts assessment which would allow for avoidance or mitigation of those impacts.
- 2.10 Mr Tavakoli undertakes not to commit like conduct on the Land in the future.
- 3. Commencement of this Undertaking**
- 3.1 This Undertaking comes into effect when:
- (a) This Undertaking is signed by Council; and
 - (b) This Undertaking is signed by Mr Tavakoli; and
 - (c) This Undertaking so executed is signed by the Secretary or his/her delegate.
 ('**Commencement Date**')

4. **Undertaking**

4.1 Mr Tavakoli undertakes for the purposes of section 9.5 of the *EP&A Act* that he will:

Works

- (a) Carry out the works shown in the Concept Drawings annexed to this Undertaking and marked with the letter 'A' ('**Concept Drawings**'), to ameliorate the environmental and community impacts ('**Remediation Works**'). The Remediation Works broadly include the works described below:
- (i) Removing Wall 2 and 3;
 - (ii) Removing of the fill behind Wall 2 and 3;
 - (iii) Installing a rock revetment seaward of Wall 1;
 - (iv) Extending the existing sea wall located on the Residence to join Wall 1;
 - (v) Including an additional small retaining wall at the upper end of Wall 1;
 - (vi) Revegetating the area uphill and retained by Wall 1;
 - (vii) Revegetating and landscaping around the Works 2;
 - (viii) Removing the chain link fence and construction of a man proof fence generally along the alignment of Wall 1 adjacent to the Residence.
- (b) The Remediation Works are to be constructed in a good and workmanlike manner, so that the Remediation Works are structurally sound, fit for purpose, and suitable for their intended use.
- (c) At the request of Mr Tavakoli, the Council will accept a design refinement to the Concept Drawings, if, in the opinion of the Council, that design refinement is required by:
- (i) any development consent made and approved under the EP&A Act or any other development consent or approval granted that relates to the Remediation Works;
 - (ii) any modification to the development consent made and approved under section 4.55 of the EP&A Act or any other development consent or approval granted that relates to the Remediation Works; and
 - (iii) conditions that were not reasonably capable of identification prior to the date of this Undertaking;
- (d) If Council accepts a design refinement to the Concept Drawings under cl 4.1(c) of this Undertaking:
- (i) the Remediation Works are to be carried out in accordance with the Concept Drawings, as amended in accordance with cl 4.1(c);
 - (ii) the certification process following the carrying out of the Remediation Works will assess the completion of the Remediation Works in accordance with the Concept Drawings, as amended in accordance with cl 4.1(c).

Security Bond for Remediation Works

- (e) Within 7 days of the signing of the Undertaking by the Secretary or his/her delegate in accordance with cl 3.1, a security bond for the Remediation Works is to be paid by Mr Tavakoli to the Council in the amount of \$491,000.
- (f) If Council accepts a design refinement to the Concept Drawings in accordance with cl 4.1(c), and the cost of that design refinement is quantified by a quantity surveyor or estimator, an additional security bond to value of those further works shall be paid by Mr Tavakoli to Council within two weeks of any such quantity surveyor's or estimator's report being served on him.

- (g) All security bonds will be deposited into the following nominated account):

Bank Name: Commonwealth Bank of Australia
Account Name: Woollahra Municipal Council
BSB: 062 156
Account: 2800 9834
Amount: \$491,000

- (h) Following the carrying out of the Remediation Works, Council will provide Mr Tavakoli with three alternative third-party independent engineers and the parties will agree to appoint one of the third-party independent engineers for the purposes of inspecting and certifying the completion of the Remediation Works in accordance with the Concept Drawings (“**Completion Certificate**”).
- (i) Upon receipt of the Completion Certificate, and satisfactory review by Council's officers, the Council will release the security bond paid for the purposes of the Remediation Works within 7 days.
- (j) If the Council acting reasonably forms the view that the Completion Certificate is unsatisfactory, it will advise Mr Tavakoli and the third party engineer within 7 days of receipt of the Completion Certificate. The Council's notification will identify the defects, errors or omissions in the Completion Certificate which, in the opinion of Council acting reasonably, prevent completion.
- (k) If, having considered the advice of the third party engineer, Council acting reasonably maintains the view that further works are required to correct the defects, errors or omissions identified in Council's notification referred to in cl 4.1(j), Mr Tavakoli will carry out the further works so advised in accordance with this clause within 6 months from the date of Council's further notification under this clause.

Approvals and Development Consent

- (l) Prior to carrying out the Remediation Works, it is Mr Tavakoli's sole responsibility to obtain all necessary development consent and approvals (including any applications under s138 of the *Roads Act 1993 (NSW)*) to carry out the Remediation Works, as well as development consent for any and all development in relation to the northern and western boundary walls required to be carried out at the Residence.
- (m) Mr Tavakoli must lodge all applications for Development Consent with Council within three months of the Commencement Date, and obtain all necessary development consents and approvals within 12 months, of the Commencement Date, unless a different timeframe is agreed between the parties.
- (n) If Mr Tavakoli fails to obtain all necessary development consents and approvals, and/or fails to carry out and complete the works within 24 months (unless a different timeframe is agreed between the parties) of the Commencement Date, the security bond and the contribution to maintenance of remediation works (see cl 4.1(e) above and cl 4.1(q) below) will be forfeited to Council.
- (o) There will be no ongoing or post completion obligations on Mr Tavakoli in respect of the maintenance for the Remediation Works, subject to cl 4.1(k).
- (p) For the avoidance of doubt, cl 4.1(n) applies if Council has determined not to accept a design refinement under cl 4.1(c) above.

Contribution to Maintenance of Remediation Works

- (q) A contribution in the amount of \$375,000, is to be paid to Council to be used by Council for the purposes of the ongoing Maintenance of Remediation Works. The contribution will be deposited into the following nominated account:

Bank Name: Commonwealth Bank of Australia

Account Name: Woollahra Municipal Council
BSB: 062 156
Account: 2800 9834

- (r) 100% of the contribution of \$375,000 will be paid to Council by Mr Tavakoli within 7 days of the signing of this Undertaking by the Secretary or his/her delegate.

Contribution to Costs Incurred

- (s) A contribution is to be paid to Council to cover (**Contribution**):

Costs	Figure
1. Costs associated with investigating and monitoring the Alleged Contraventions and entering into this Undertaking.	\$11,025
2. Legal costs associated with prosecuting Mr Tavakoli and the Company up to the date of signing of this Undertaking.	\$369,000
3. Predicted legal costs associated with prosecuting the Company from the date this Undertaking is signed to the completion of sentence proceedings against it.	\$100,000
4. Predicted fines imposed against the Company.	\$150,000
5. Costs of the remediation plan	\$52,000
Total	\$682,025

- (t) The Contribution of \$682,025 will be deposited into the following nominated account:

Bank Name: Commonwealth Bank of Australia
Account Name: Woollahra Municipal Council
BSB :062 156
Account :2800 9834

- (u) 100% of the Contribution will be paid to Council by Mr Tavakoli within 7 days of the signing of this Undertaking by the Secretary or his/her delegate.

- (v) Upon payment by the Company of any and all fines ordered by the Land and Environment Court in Proceedings Nos. 2023/451457; 2023/451458; 2023/451459; 2023/451460; 2023/451461, and of costs ordered by the Court to be paid by the Company in those proceedings, Council will refund the Contribution amounts referred to at points 3 and 4 in the table above to Mr Tavakoli. If these amounts are not paid by the Company by the respective dates by which they fall due as ordered by the Court, the amounts comprising Contribution points 3 and 4 in the table above will be forfeited to Council.

- (w) Within 30 days after the ^{Housing} Commencement Date Mr Tavakoli will pay the Department of Planning and Infrastructure the sum of \$1,000 for legal costs associated with accepting this Undertaking.

(Departmental Costs)

(x) The Departmental Costs will be deposited into the following account:

Bank: Westpac
Account Name: DPIE Operating CC No 2
BSB: 032-001
Account Number: 114428

4.2 Mr Tavakoli will implement the following to satisfy the Council that the undertakings have been complied with:

- (a) Email Rosemary Bullmore at Rosemary.Bullmore@woollahra.nsw.gov.au, a copy of the bank statement or transaction receipt that confirms the payment of the security bond for Remediation Works described in cl 4.1(e) above, within 7 days of making that payment;
- (b) Email Rosemary Bullmore at Rosemary.Bullmore@woollahra.nsw.gov.au, a copy of the bank statement or transaction receipt that confirms the payment of the contribution for maintenance of the Remediation Works described in cl 4.1(q) above, within 7 days of making that payment; and
- (c) Email Rosemary Bullmore at Rosemary.Bullmore@woollahra.nsw.gov.au, a copy of the bank statement or transaction receipt that confirms the payment of the contribution for costs incurred described in cl 4.1(s) above, within 7 days of making that payment.
- (d) Email to the Director - Compliance of the Department of Planning, Housing and Infrastructure at compliance@planning.nsw.gov.au enclosing a copy of the bank statement or transaction receipt which confirms that the payment described in paragraphs 4.1 (w) & (x) has been made, within 7 days of making that payment.

5. Acknowledgements

5.1 The Council acknowledges:

- (a) Once this Undertaking has been signed by the Planning Secretary or his/her delegate and the Company has entered pleas of guilty to the charges in Land and Environment Court Proceedings Nos 2023/451457-451461, and Mr Tavakoli has paid the Security Bond, the Maintenance of Remediation Works amount and the Contribution amount, it will withdraw Land and Environment Court Proceedings Nos. 2023/451429; 2023/451430; 2023/451431; 2023/451432; 2023/451433 ('Proceedings') against Mr Tavakoli;
- (b) The withdrawal of the Proceedings will be with no order as to costs.

5.2 Mr Tavakoli acknowledges:

- (a) Upon the signing of this Undertaking by the Planning Secretary or his/her delegate, Mr Tavakoli, as director of the Company, will provide instructions for the Company to enter guilty pleas to the charges against it in Land and Environment Court Proceedings Nos 2023/451457- 451461.
- (b) The Department of Planning, Housing and Infrastructure (**NSW Planning**) may make this Undertaking publicly available including by publishing it on the NSW Planning's public register of section 9.5 undertakings on its website, and may refer to it in media or publications;
- (c) This Undertaking will be tendered by the Prosecutor the proceedings against the Company;
- (d) This Undertaking in no way derogates from the rights and remedies available to any other person arising from the Alleged Contraventions; and

- (e) The NSW Planning may include details of any compliance audits it undertakes of this Undertaking, including records provided under cl 4.1 of this Undertaking, with this Undertaking in the public register.

6. A Statement of Capacity to Comply with the Terms of the Undertaking

- 6.1 Mr Tavakoli certifies that he has the financial ability to comply with the terms of this Undertaking.

Executed as an Enforceable Undertaking under Section 9.5 of the *Environmental Planning and Assessment Act 1979 (NSW)*

Signed:	
Name:	Arash Tavakoli
Date:	13/03/2025


The Council has negotiated the Undertaking with Mr Tavakoli in relation to the Council's functions under the *EP&A Act* and recommends that the Secretary accept the Undertaking

Signed:	
Name:	Craig Swift-McNair
Position	General Manager
Date:	14 February 2025

Accepted by the Planning Secretary of the Department of Planning, Housing and Infrastructure pursuant to Section 9.5 of the *Environmental Planning and Assessment Act 1979 (NSW)*

Signed:	
Name:	David Gainsford
Position	Deputy Secretary
Date:	Development Assessment and Sustainability 21/03/2025

A

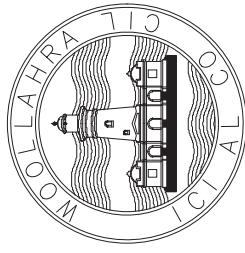

WOOLLAHRA □ MUNICIPAL □ COUNCIL BAYVIEW □ HILL □ ROAD □ SEA □ WALL □ & □ RETAINING □ WALLS DESIGN

CIVIL □ INFRASTRUCTURE □ WORKS

LOCALITY □ PLAN



DRAWING □ SCHEDULE

DWG □ No.	DRAWING □ TITLE	REV	DATE
24-009C-01	COVER □ PAGE	3	05/03/25
24-009C-02	SPECIFICATIONS □ AND □ NOTES	2	05/03/25
24-009C-03	SPECIFICATIONS □ AND □ NOTES □ SEAWALL-01	2	05/03/25
24-009C-04	SPECIFICATIONS □ AND □ NOTES □ SEAWALL-02	2	05/03/25
24-009C-10	LAYOUT □ PLAN □ DRAINAGE	2	05/03/25
24-009C-11	NORTH □ ELEVATION	3	11/03/25
24-009C-20	LAYOUT □ PLAN □ SEAWALL	2	05/03/25
24-009C-21	SETOUT □ PLAN □ SEAWALL	3	05/03/25
24-009C-22	SEAWALL □ SECTIONS-01	3	11/03/25
24-009C-23	SEAWALL □ SECTIONS-02	3	11/03/25
24-009C-24	SEAWALL □ SECTIONS-03	3	11/03/25
24-009C-25	SEAWALL □ SECTIONS-04	2	05/03/25
24-009C-30	LAYOUT □ PLAN □ RETAINING □ WALLS (SUBJECT □ TO □ STRUCTURAL □ ENGINEERING □ INPUT)	3	11/03/25
24-103-S1.01	PLAN □ RETAINING □ WALLS (SUBJECT □ TO □ STRUCTURAL □ ENGINEERING □ INPUT)	1	16/07/24
24-103-S1.02	RETAINING □ WALLS □ SECTIONS (SUBJECT □ TO □ STRUCTURAL □ ENGINEERING □ INPUT)	1	16/07/24
24-009C-40	LAYOUT □ PLAN □ LANDSCAPING	2	05/03/25
24-009C-45	LAYOUT □ SEDIMENT □ CONTROL	1	05/03/25
24-009C-50	DRAINAGE □ LAND □ SEDIMENT □ CONTROL □ DETAILS	1	05/03/25
24-009C-51	PLANTING □ SCHEDULE	1	05/03/25

CONSULTANT



GENERAL

1. THE DRAWINGS SHOW THE WORKS TO BE SUPPLIED AND INSTALLED BY THE CONTRACTOR, UNLESS NOTED AS EXISTING OR BY OTHERS".
 2. ALL MATERIALS TO BE SUPPLIED AND INSTALLED BY THE CONTRACTOR SHALL BE NEW.
 3. THE DRAWINGS SHALL BE READ IN CONJUNCTION WITH ALL OTHER DRAWINGS, SPECIFICATIONS AND WITH SUCH OTHER WRITTEN INSTRUCTIONS AS MAY BE ISSUED DURING THE COURSE OF THE CONTRACT.
 4. BEFORE UNDERTAKING ANY WORK, ESTABLISH THE LOCATIONS OF ALL EXISTING SERVICES AFFECTED BY THE WORKS. IF NECESSARY, CARRY OUT BEFORE YOU DIG, AUSTRALIA SEARCH, ADVISE THE SUPERINTENDENT IF THERE ARE ANY PREVIOUSLY UNKNOWN SERVICES THAT CAN POTENTIALLY BE AFFECTED BY THE WORKS.
 5. ALL CRITICAL ARRANGEMENTS AND DIMENSIONS SHALL BE VERIFIED BY THE CONTRACTOR ON SITE BEFORE WORK COMMENCES.
 6. DRAWINGS SHALL NOT BE SCALED FOR DIMENSIONS.
 7. DIMENSIONS AND LEVELS ARE DEPICTED IN MILLIMETRES AND METERS AS DENOTED ON THE DRAWINGS.
 8. ALL LEVELS ARE RELATIVE TO AUSTRALIAN HEIGHT DATUM (AHD) UNLESS OTHERWISE NOTED.
 9. ANY DISCREPANCY ON THE DRAWINGS SHALL BE REFERRED TO THE SUPERINTENDENT BEFORE PROCEEDING WITH THE WORK.
 10. ALL MATERIALS AND WORKMANSHIP SHALL BE IN ACCORDANCE WITH THE RELEVANT AND CURRENT AUSTRALIAN STANDARDS AND WITH THE BY-LAWS AND ORDINANCES OF THE RELEVANT BUILDING AUTHORITIES EXCEPT WHERE VARIED BY THE SPECIFICATION HEREIN AND THE DRAWINGS.
 11. DURING CONSTRUCTION THE STRUCTURE SHALL BE MAINTAINED IN A STABLE CONDITION AND NO PART SHALL BE OVERSTRESSED TEMPORARILY. BRACING AND BATTERS SHALL BE PROVIDED BY THE CONTRACTOR TO KEEP THE WORKS AND EXCAVATIONS STABLE.

QUALITY □ ASSURANCE

DESIGN CRITERIA

16. DESIGN LEVELS: FOR THE CONSTRUCTED SEAWALL SHALL BE MINIMUM 100 YEARS AND FOR ALL OTHER MATERIALS UNLESS NOTED OTHERWISE, SHALL BE A MINIMUM 25 YEARS WITH PERIODIC INSPECTION AND MAINTENANCE.

17. DESIGN LEVELS ARE BASED ON THE FOLLOWING:

 - PREDICTED SEA LEVEL RISE (SLR) OF 0.53 M FOR A 100 YEAR SCENARIO.
 - WIND SET UP OF 0.1M BASED ON A 10 YEAR ANNUAL EXCERDANCE PROBABILITY (AEP) FOR THE DESIGN STORM EVENT.
 - AVERAGE CLIMATE COMPRISING OF WIND WAVES ($H_s = 0.34 \text{ m}$ and $T_p = 1.36 \text{ sec}$) AND VESSEL WAVES ($H_s = 0.35 \text{ m}$).
 - EXISTING TIDAL LEVELS ARE DERIVED AND HAVING A TIDE GAUGE (MHWs = 0.65 M AND HAT = -18 M).

18. APPROXIMATELY 300M FROM THE WATERS EDGE OF THE EXISTING SEAWALL, THE SURVEY SHALL BE MARKED OUT ON SITE USING A STRING LINES AND INCLUDE A CONTINUOUS CONTROL LINE REPRESENTING THE SEAWALL ALIGNMENT BETWEEN NCH-OM AND CH-46M WITH INTERNAL MARKERS.

29. THE CONTRACTOR SHALL SEEK APPROVAL FROM THE SUPERINTENDENT FOR THE PROPOSED SET OUT OF THE WORKS ON SITE (HOLD POINT 1), WHERE THE ALIGNMENT OR LEVELS FOR THE EXISTING SEAWALL CREST DIFFER FROM THE EXISTING SURVEY OR SET OUT IN THE DRAWINGS. THE SUPERINTENDENT MAY GIVE DIRECTION TO THE CONTRACTOR TO ADJUST THE CONTROL LINE TO COORDINATE WITH EXISTING CONDITIONS WHILST ACHIEVING THE DESIGN INTENT OF THE DRAWINGS AND SPECIFICATION.

STANDARD PROPERTY

- a) AS/T1141.6.1 MINIMUM DRY BULK DENSITY 2500kg/m³
 b) AS/T1141.6.2 WATER ABSORPTION < 1.5%
 c) AS/T1141.6.2 WET DRY STRENGTH □ 30%
 d) AS/T1141.6.2 POINT LOAD STRENGTH¹ (IS50) ≥ 5 MPa
 e) ASTM C98M MIN WET MODULUS OF RUPTURE² 31 MPa
 f) AS/T1141.26 RESISTANCE TO SALT ATTACK MAX. 50% SODIUM SULPHATE WEIGHT LOSS OF < 9%

39. SANDSTONE BLOCKS SHALL HAVE THE FOLLOWING DIMENSIONS;
 1M LENGTH □ 0.5 M WIDTH AND 0.3M HEIGHT □ THE BLOCKS SHALL HAVE A CHAMFER OR PENCIL ROUND FINISH ALONG ALL EDGES.

STONE MASONARY

38. SANDSTONE BLOCKS USED IN THE WORKS SHALL BE APPIN STONE OR SIMILAR APPROVED, HAVING THE FOLLOWING PROPERTIES.

STANDARD PROPERTY

STANDARD	PROPERTY
a) AS/N1141.6.1	MINIMUM DRY BULK DENSITY WATER ABSORPTION < 1.5%
b) AS/N1141.6.2	WET DRY STRENGTH VARIATION < 30%
c) AS/N1141.22	POINT LOAD STRENGTH (IS50) ≥ 5 MPa
d) AS/N143.4.1	MIN WET MODULUS OF RUPTURE ≥ 35 MPa
e) ASTM C93M	RESISTANCE TO SALT ATTACK
f) AS/N1441.26	MAX. SODIUM SULPHATE WEIGHT LOSS OF < 9%

39. SANDSTONE BLOCKS SHALL HAVE THE FOLLOWING DIMENSIONS: 1M LENGTH, 0.5M WIDTH AND 0.3M HEIGHT. THE BLOCKS SHALL HAVE A CHAMFER OR PENCIL ROUND FINISH ALONG ALL EDGES.

DEMOLITION

33. CARRY OUT DEMOLITION WORK IN ACCORDANCE WITH AS/NZS 2601, MAKING DUE ALLOWANCE FOR THE DETERIORATED CONDITION OF THE STRUCTURE.
 34. PROTECT PROPERTY AND SERVICES WHICH ARE TO REMAIN ON OR ADJACENT TO THE SITE.
 35. LAWFULLY DISPOSE OF ALL DEMOLITION MATERIALS.
 36. ITEMS TO BE DEMOLISHED SHALL BE COMPLETELY REMOVED CLEAR OF THE EXISTING SEAWALL FOOTPRINT AND ADJACENT RESERVE.
 37. ALL DEBRIS SHALL BE COMPLETELY REMOVED CLEAR OF THE WATERS AND RELOCATED TO THE PIVER

CONSTRUCTION METHODS

26. THE INTENT OF THE WORKS IS TO INSTALL ADDITIONAL VERTICAL SANDSTONE BLOCKS OVER THE EXISTING SEAWALL CREST ALIGNMENT. THE LAYOUT OF THE WORKS MUST ENSURE THAT SUFFICIENT CONTACT IS ACHIEVED BETWEEN THE EXISTING SEAWALL CREST AND LOWER COURSE OF THE NEW SANDSTONE BLOCKS USING A MORTAR BED (20MM MINIMUM DEPTH).

27. THE ALIGNMENT FOR THE SEAWALL WORKS IS SHOWN IN THE DRAWINGS DEPICTS THE WATERSIDE FACE OF THE NEWLY INSTALLED SANDSTONE BLOCKS.


28. THE CONTRACTOR SHALL UNDERTAKE A PRE-CONSTRUCTION SURVEY TO SET OUT THE WORKS IN ACCORDANCE WITH THE DRAWINGS AND SPECIFICATION. THE INTENET OF THE SET OUT IS TO ESTABLISH A SMOOTH CONTINUOUS ALIGNMENT FOR THE INSTALLATION OF SANDSTONE BLOCKS WHICH IS OFFSET APPROXIMATELY 150MM FROM WATERSIDE EDGE OF THE EXISTING SEAWALL. THE SURVEY SHALL BE MARKED OUT ON SITE USING A STRING LINE AND INCLUDE A CONTINUOUS CONTROL LINE REPRESENTING THE SEAWALL ALIGNMENT BETWEEN CH OM AND CH 46M WITH INTERVAL MARKERS.

29. THE SUPERINTENDENT FOR THE PROPOSED SET OUT OF THE WORKS ON SITE (HOLD POINT), WHERE THE ALIGNMENT OR LEVELS, FOR THE EXISTING SEAWALL, DIFFER FROM THE EXISTING SURVEY OR SET OUT IN THE DRAWINGS, THE SUPERINTENDENT MAY GIVE DIRECTION TO THE CONTRACTOR TO ADJUST THE CONTROL LINE TO COORDINATE WITH EXISTING CONDITIONS WHILST ACHIEVING THE DESIGN INTENT OF THE DRAWINGS AND SPECIFICATION.

STONEMASONARY

	PROPERTY
38. SANDSTONE BLOCKS USED IN THE WORKS SHALL BE APPIN STONE OR SIMILAR APPROVED, HAVING THE FOLLOWING PROPERTIES.	STANDARD PROPERTY
	STANDARD
a) AS 1141.6.1	MINIMUM DRY BULK DENSITY
b) AS 1141.6.2	WATER ABSORPTION < 1.5%
c) AS 1141.22	WET DRY STRENGTH VARIATION < 30%
d) AS 1133.4.1	POINT LOAD STRENGTH (IS50) ≥ 50 MPa
e) ASTM C99M	MIN. WET MODULUS OF RUPTURE ≥ 3 MPa
f) AS 1141.26	RESISTANCE TO SALT ATTACK MAX. 10% SULPHATE WEIGHT LOSS ≤ 9%

39. SANDSTONE BLOCKS SHALL HAVE THE FOLLOWING DIMENSIONS: 1M LENGTH, 0.5M WIDTH, AND 3M HEIGHT. THE BLOCKS SHALL HAVE A CHAMFER OR PENCIL ROUND FINISH ALONG ALL EDGES.

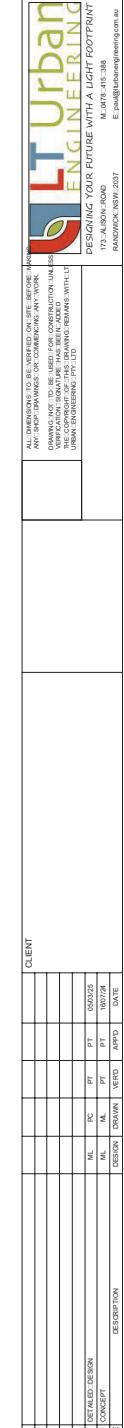


40. THE FOLLOWING STANDARDS SHALL BE COMPLIED WITH FOR THE STONEMASONRY TO THE EXTENT THAT THEY ARE RELEVANT AND NOT OVERRIDDEN BY THE SPECIFICATION:
- AS 3972 GENERAL PURPOSE AND BLEND CEMENTS.
 - AS 1141 METHODS FOR SAMPLING AND TESTING AGGREGATES.
 - AS 1672 LIMES AND LIMESTONES FOR BUILDING.
 - AS 2701 METHODS OF SAMPLING AND TESTING MORTAR FOR MASONRY CONSTRUCTIONS.
 - AS 4489 TEST METHODS FOR LIMES AND LIMESTONES.
 - ASTM C97 STANDARD TEST METHODS FOR ABSORPTION AND BULK SPECIFIC GRAVITY OF DIMENSION STONE.
 - ASTM C99 STANDARD TEST METHODS FOR MODULUS OF RUPTURE OF DIMENSION STONE.
 - ASTM C170 STANDARD TEST METHODS FOR COMPRESSIVE STRENGTH OF DIMENSION STONE.
 - ASTM C1489-01 STANDARD SPECIFICATION FOR LIME PUTTY FOR STRUCTURAL PURPOSES.
 - ASTM C1496-01 STANDARD GUIDE FOR ASSESSMENT AND MAINTENANCE OF EXTERIOR DIMENSION STONE MASONRY.
 - ASTM C1713-10 STANDARD SPECIFICATION FOR MORTARS FOR THE REPAIR OF HISTORIC MASONRY.
 - AS 4456 MASONRY UNITS AND SEGMENTAL PAVERS - METHODS OF TEST.
41. THE COLOUR AND DISTRIBUTION OF NEW SANDSTONE BLOCKS SHALL BE SIMILAR TO THE EXISTING COLOURED PATTERN OF THE SEA WALL.
42. ALL WORKED STONE SHALL BE INSPECTED ON SITE PRIOR TO INSTALLATION STONE FOUND UNACCEPTABLE FOR ITS SPECIFIC PURPOSE SHALL BE REJECTED.
43. AT LEAST FOURTEEN (14) DAYS PRIOR TO THE SUPPLY OF ANY SANDSTONE BLOCKS, THE CONTRACTOR SHALL PROVIDE DOCUMENTATION TO THE SUPERINTENDENT THAT DEMONSTRATES THAT THE BLOCKS TO BE SUPPLIED COMPLY WITH THE REQUIREMENTS OF THIS SPECIFICATION.
44. REUSE OF EXISTING SANDSTONE BLOCKS SHALL NOT BE PERMITTED UNLESS DIRECTED BY THE SUPERINTENDENT.
45. THE CONSTRUCTED WALL SHALL BE SET OUT IN LINE USING OFFSETS FROM A DATUM LINE TO BE ESTABLISHED BY THE CONTRACTORS SURVEYOR.
46. THE CONTRACTOR SHALL BE RESPONSIBLE FOR THE ACCURACY OF THE STONE SET-OUT AND SHALL MAKE GOOD ANY INACCURACIES AT HIS OWN COST TO THE SATISFACTION OF THE SUPERINTENDENT.
47. STONE SHALL BE FREE FROM CRACKS, VENTS, SANDBALLS, FISSURES, SHALE INCLUSIONS, TEA LEAF CLEAVAGE PLANES, JOINTS, SEAMS, CHEMICAL ALTERATION AND OTHER DEFECTS WHICH WOULD BE LIKELY TO AFFECT ITS STRENGTH, APPEARANCE, DURABILITY AND PERFORMANCE IN THE MARINE ENVIRONMENT.
48. STONEMASONRY SHALL BE CARRIED OUT BY A SKILLED AND EXPERIENCED STONEMASON.
49. BEDDING AND POINTING MORTAR SHALL CONSIST OF 1:ST:ASTER NATURAL HYDRAULIC LIME (NHL) 3.5: MIXED IN THE RATIO 1:1:2 WITH WELL-GRADED, CLEAN, SHARP SAND. CARE SHOULD BE TAKEN NOT TO ADD ANY MORE WATER THAN IS ABSOLUTELY NECESSARY AS AN EXCESSIVE AMOUNT OF WATER WILL LEAD TO SHRINKAGE OF THE GROUT ON CURING.
50. JOINT AND BEDDING MORTAR SHALL HAVE A MINIMUM DEPTH OF 20MM.
52. ALL STONE BLOCKS SHALL BE CORRECTLY AND ACCURATELY SET IN A LEVEL AND POSITION IN COURSES ON THEIR NATURAL QUARRY BED. IN THE SETTING OF THE STONE BLOCKS, CARE SHALL BE TAKEN TO ENSURE THAT NO MORTAR, EITHER SPILLAGE OR FROM OVER FILLING, SHALL COME IN CONTACT WITH THE FACE OF THE STONE. PRIOR TO ANY SPECIFIED MORTAR BEDDING, CLEAN THE BED AREA OF DUST AND IMPURITIES AND THOROUGHLY DAMP IT DOWN BEFORE LAYING THE MORTAR BED. LAY EACH STONE ON A FULL BED OF MORTAR AND TAP HOME. PACKERS SHALL NOT BE USED. SOLIDLY FILL AND GROUT JOINTS AND JOGGLES WHERE SPECIFIED AS THE WORK PROCEEDS.
53. TO PROTECT AGAINST DIFFERENTIAL EROSION, CEMENT MORTARS THAT ARE HARDER THAN THE SANDSTONE SHALL NOT BE USED IN THE WORKS UNLESS AGREED OTHERWISE BY THE SUPERINTENDENT. ALL SAND, CEMENT AND LIME USED IN THE MORTAR MIX SHALL BE IN ACCORDANCE WITH AS3700. □ MORTAR STRENGTH □ AFTER 28 DAYS SHALL BE GREATER THAN 3.5 MPa. □ ADMIXTURES SHALL BE SUITABLY PROPORTIONED IN ACCORDANCE WITH THE REQUIREMENTS OF AS3700. □ THE RAW MATERIALS SHALL CONFORM TO THE REQUIREMENTS OF AS3700. □ PARTICULAR ATTENTION SHALL BE PAID TO THE EXACT MEASUREMENT OF MORTAR CONTENTS AND THE MIXING PROCEDURE. □ THE COLOUR OF THE EXISTING MORTAR SUCH THAT REPAIRS TO THE STONEMASONRY ARE NOT CONSPICUOUS. □ WITHOUT COMPROMISING MORTAR STRENGTH, AIMED THE MORTAR MIX DESIGN IN CONSULTATION WITH THE SUPERINTENDENT AND THE CITY OF CANADA BAY AS REQUIRED TO ACHIEVE COLOUR REQUIREMENTS.
54. NEW MORTAR JOINTS ARE TO MATCH THE EXISTING OR TO BE AS DIRECTED ON SITE BY THE SUPERINTENDENT. □ ALL EXISTING JOINT LINES SHALL BE MAINTAINED WHERE IT IS UNCLEAR WHERE EXISTING JOINT LINES CARE, □ NOTICE THE SUPERINTENDENT ON SITE FOR A DETERMINATION □ RAKE OUT JOINTS TO TAKE POINTING MATERIAL PROVIDED □ A SAMPLE AREA OF ONE SQUARE METRE □ METRE OF POINTING IN STONEWORK FOR APPROVAL. □ ALL STONE IS TO BE THOROUGHLY DAMPENED BEFORE POINTING BUT SHALL BE FREE OF EXCESS WATER WHEN POINTING IS CARRIED OUT.
55. ON COMPLETION OF LAYING NEW STONES ALL JOINTS SHALL BE RAKED OUT TO A MINIMUM DEPTH OF 3.0 TIMES THE WIDTH OF THE JOINT AND CLEANED READY TO TAKE POINTING ALL AS DIRECTED BY THE SUPERINTENDENT.
56. FOLLOWING GROUTING AND PARTIAL CURING OF THE GROUT, THE BACKING ROD SHALL BE REMOVED AND THE JOINTS REPOINTED AS SPECIFIED ABOVE. □ NO CLOSED CELL POLYETHYLENE BACKING ROD SHALL REMAIN IN THE JOINTS. POINTING SHALL BE FINISHED FLUSH WITH THE STONEMWORK OR BE SLIGHTLY RECESSED WHERE ARRISSES ARE WORN OR POINTING TO JOINTS SHALL BE FINISHED WITH A LIGHT BRUSH.
57. ON COMPLETION OF LAYING NEW STONES ALL JOINTS SHALL BE RAKED OUT TO A MINIMUM DEPTH OF 3.0 TIMES THE WIDTH OF THE JOINT AND CLEANED READY TO TAKE POINTING ALL AS DIRECTED BY THE SUPERINTENDENT.
58. FOLLOWING GROUTING AND PARTIAL CURING OF THE GROUT, THE BACKING ROD SHALL BE REMOVED AND THE JOINTS REPOINTED AS SPECIFIED ABOVE. □ NO CLOSED CELL POLYETHYLENE BACKING ROD SHALL REMAIN IN THE JOINTS. POINTING SHALL BE FINISHED FLUSH WITH THE STONEMWORK OR BE SLIGHTLY RECESSED WHERE ARRISSES ARE WORN OR POINTING TO JOINTS SHALL BE FINISHED WITH A LIGHT BRUSH.
59. FINISHED POINTING MORTAR SHALL BE PROTECTED FROM RAIN AND FROM INHIBITION OF THE CARBONATION PROCESS RESPECTIVELY RESULTING IN BOTH INSTANCES IN WEAKENING OF THE MORTAR. □ DIRECT SUN, HEAT AND WIND ARE KEY CONTRIBUTORS TO RAPID DRYING. □ AS THIS CAN LEAD TO LEACHING OF PLASTIC SHEETING AT THE END OF EACH DAY'S WORK TO PREVENT UNWANTED WETTING OR RAPID CURING OF THE MORTAR.
60. AND FROM RAPID DRYING. □ AS THIS CAN LEAD TO LEACHING OF PLASTIC SHEETING AT THE END OF EACH DAY'S WORK TO PREVENT UNWANTED WETTING OR RAPID CURING OF THE MORTAR.
61. THE WORKS SHALL BE COVERED IN HESSIAN AND HEAVY-DUTY PLASTIC SHEETING AT THE END OF EACH DAY'S WORK TO PREVENT UNWANTED WETTING OR RAPID CURING OF THE MORTAR.
62. ON COMPLETION OF THE STONEMASONRY WORKS, THE STONEMWORK SHALL BE CLEANED DOWN TO REMOVE ALL DUST, DEBRIS, AND OTHER GENERAL SOILING USING FRESH WATER AND PRESSURE WASHER. MAY BE USED, STRICTLY SUBJECT TO THE FOLLOWING LIMITATIONS:
- MATERIAL COMPRISING THE FINISHED SURFACE OF THE WORK ITEM
 - OUTER FACE OF SEAWALL (WATER SIDE)
 - JOINTS
- a. MAXIMUM PRESSURE 7430psi (3000kPa)
MINIMUM DISTANCE OF WASHER HEAD FROM THE SANDSTONE: 200mm.
THE CONTRACTOR SHALL MEET CONSTRUCTION TOLERANCES FOR THE STONEMASONRY AS DETAILED BELOW:
- b. HORIZONTAL
OUTER FACE OF SEAWALL 25mm
WATER SIDE 20mm
c. VERTICAL
HORIZONTAL
JOINTS 15mm/+15mm
63. THE CONTRACTOR SHALL MEET CONSTRUCTION TOLERANCES FOR THE STONEMASONRY AS DETAILED BELOW:
- SURVEY
64. ALL LEVELS ARE TO AUSTRALIAN HEIGHT DATUM (AHD) AND HORIZONTAL POSITIONING TO THE MAP GRID OF AUSTRALIA (MGA).
65. THE CONTRACTOR SHALL CONSIDER THE EXISTING SURVEY AS INDICATIVE ONLY. □ THE CONTRACTOR SHALL ACCOUNT FOR LEVELS AND SLOPES OF SURFACES AND UNPROTECTED SHORELINES BEING CORRECT AT THE TIME OF SURVEY, BUT POTENTIALLY CHANGING OVER TIME DUE TO DEGRADATION AND MOVEMENT OF THE SEAWALL CREST. □ THE CONTRACTOR SHALL CONFIRM ALL REQUIRED LEVELS, PRIOR TO CONSTRUCTION BY UNDERTAKING A PRE-CONSTRUCTION SURVEY.
66. PRIOR TO THE COMMENCEMENT OF ANY WORKS THE CONTRACTOR SHALL ARRANGE FOR SURVEYED CROSS SECTION SURVEYS OF THE FULL WIDTH OF THE CONSTRUCTED SEAWALL CREST.
67. SURVEY SHALL BE CARRIED OUT BY A SUITABLY EXPERIENCED AND QUALIFIED REGISTERED SURVEYOR. □ THE SUPERINTENDENT SHALL BE PROVIDED WITH TWO COPIES OF A1 SIZE DRAWINGS OF THE SURVEY DETAILING ALL THE CROSS-SECTIONS AT 1:200 SCALE AND PLANS DETAILING CROSS-SECTION LOCATIONS AT 1:200 SCALE. □ THE CONTRACTOR WILL BE RESPONSIBLE FOR ANY FURTHER SURVEY REQUIRED DUE TO THE WORK BEING INCOMPLETE OR NOT COMPLYING WITH THE DRAWINGS AND SPECIFICATION.


PLOT/BED LOCATION: C:\Users\mark\DATA\1010\24\LT Urban Engineering.dwg	PROJECT: RETAINING AND SEAWALL BAYVIEW HILL ROAD ROSE BAY	DRAWING TITLE: SEAWALL	STATUS: DETAILED DESIGN
2 DRAFTED DESIGN	ML PC PT 06/02/05	SEAWALL NOTES & SPECIFICATIONS: 02	PROJECT No.: 24-009C
1 CONCEPT	ML TA PT 19/07/04		DWG No.: 24-009C-04
NAME: [Redacted]	DESIGNER: [Redacted] DATE: [Redacted]		PAPER: A3 ISSUE: 2

LT Urban
Engineering


17 AUGUST 2005
RANDBLOCK NSW 2317
M. 028 415 388
E. psd@australianengineering.com.au

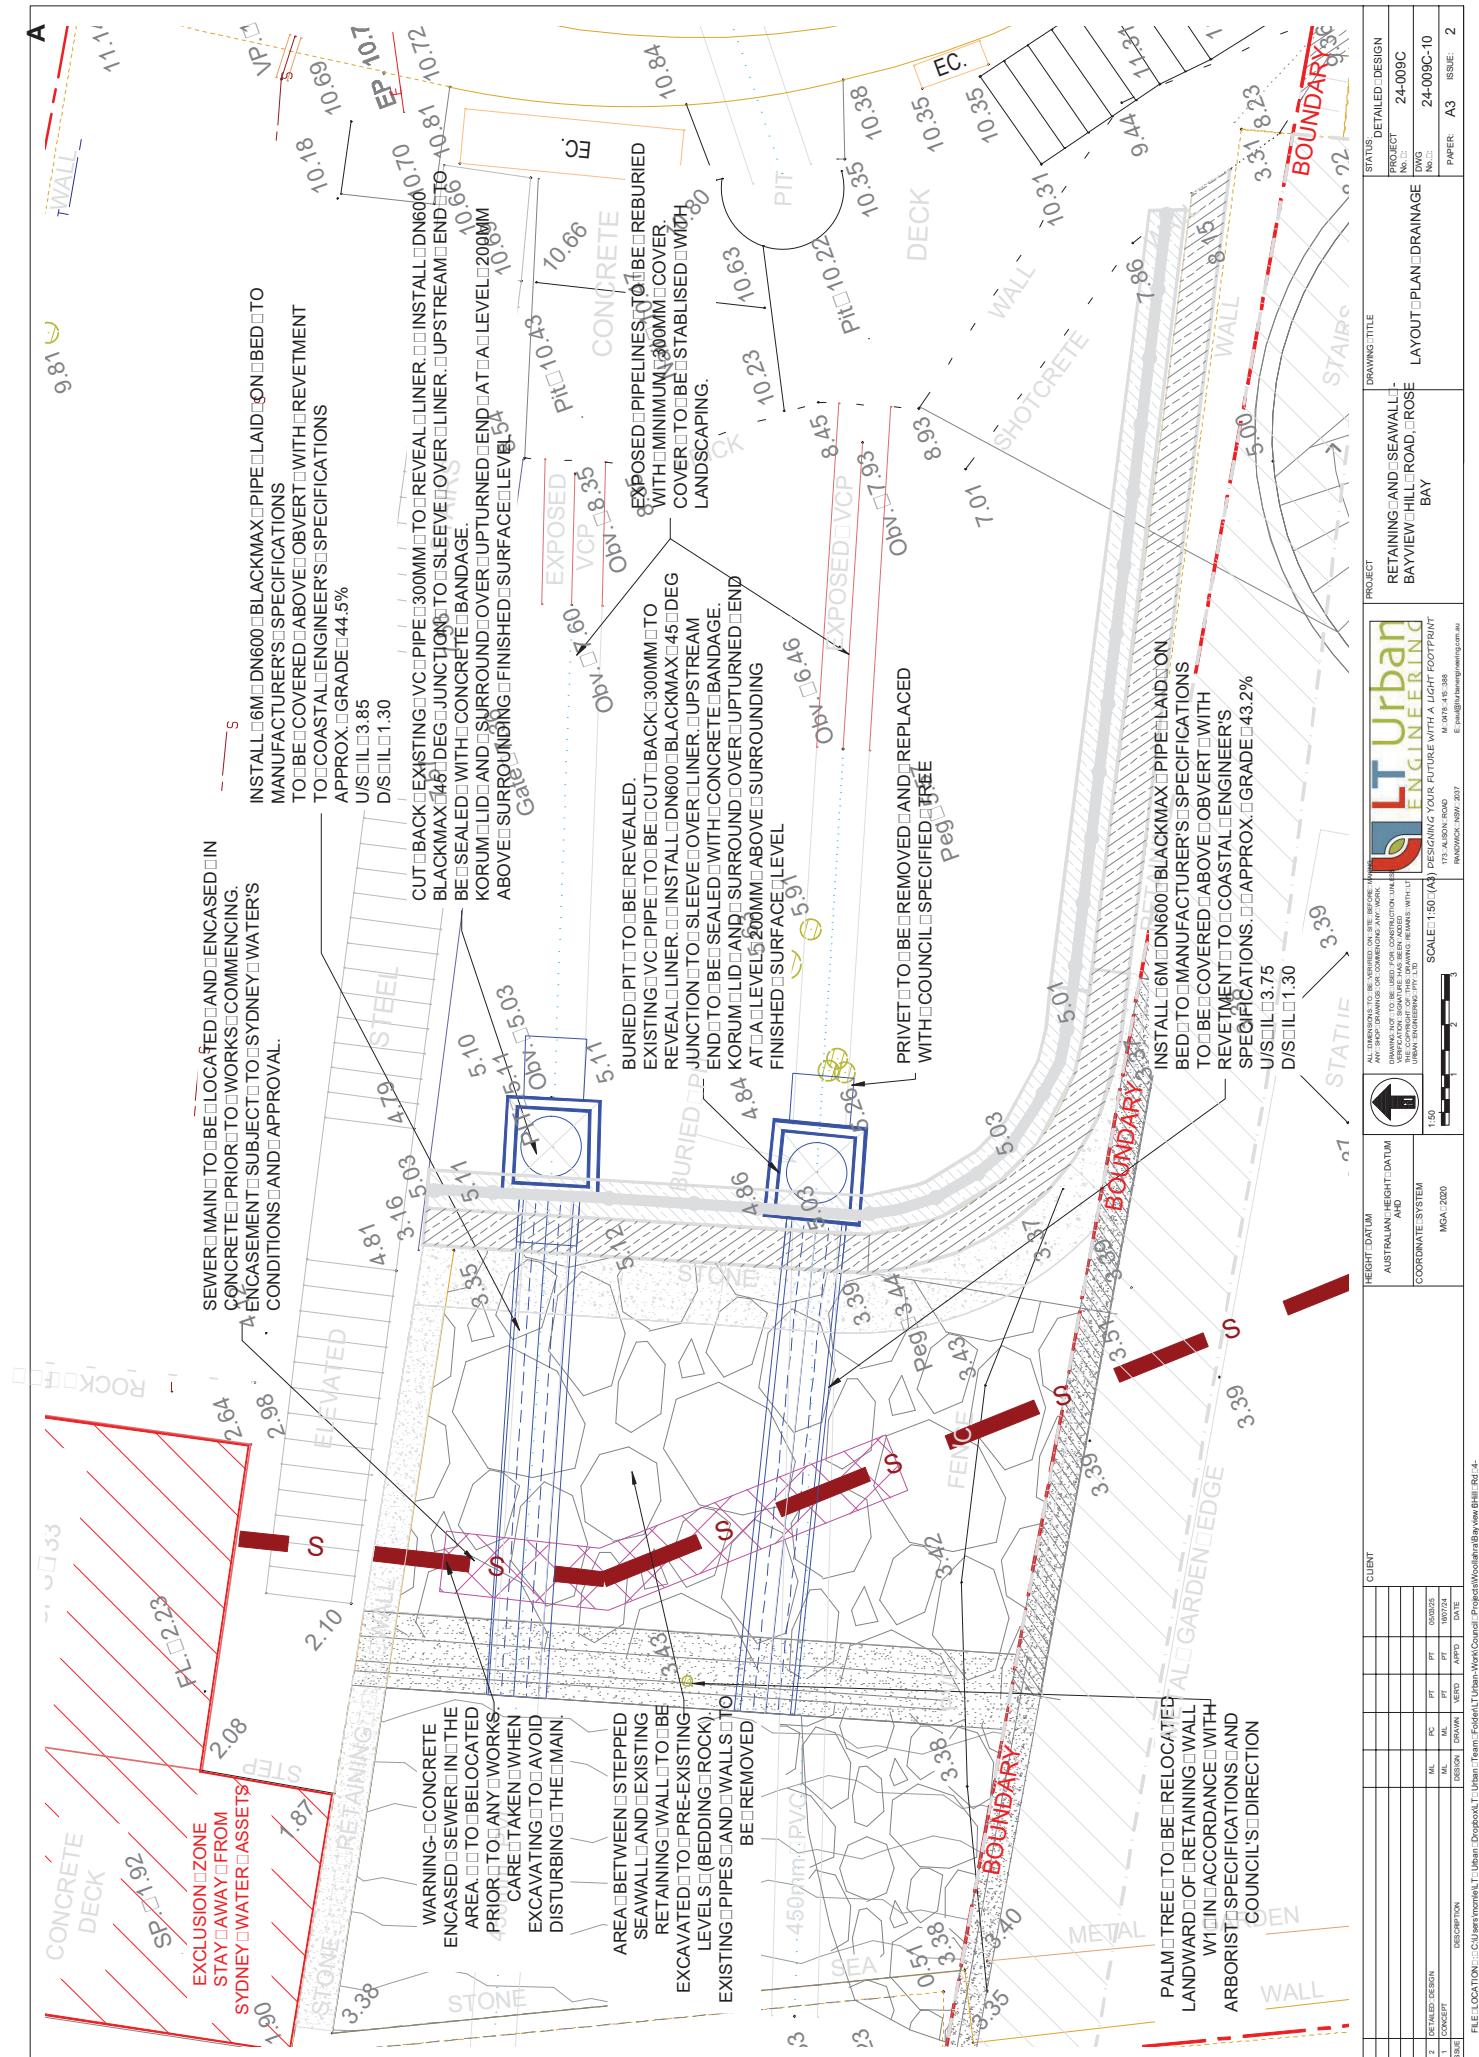


A

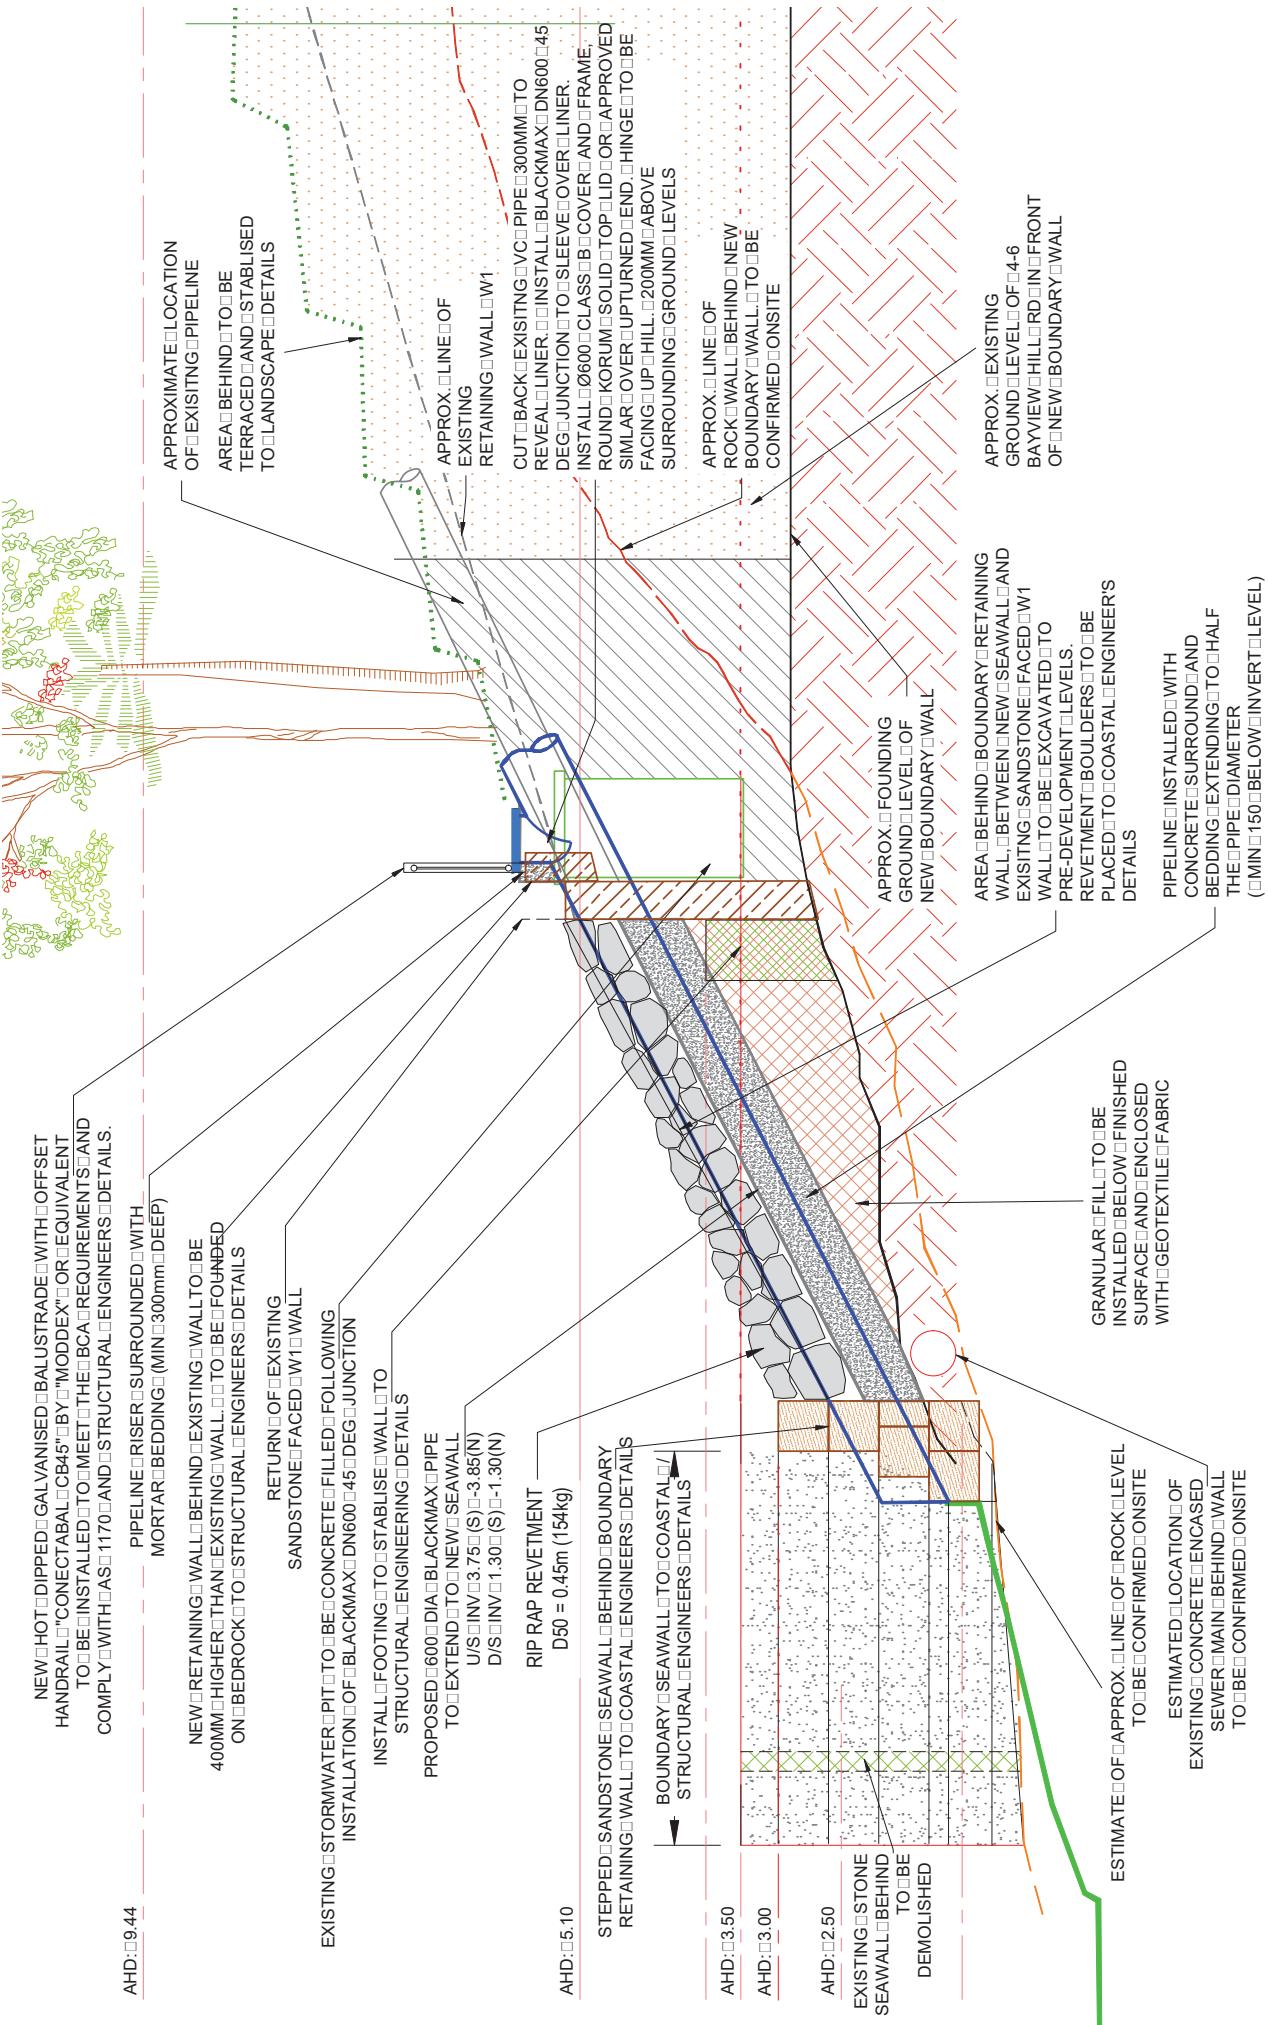

A

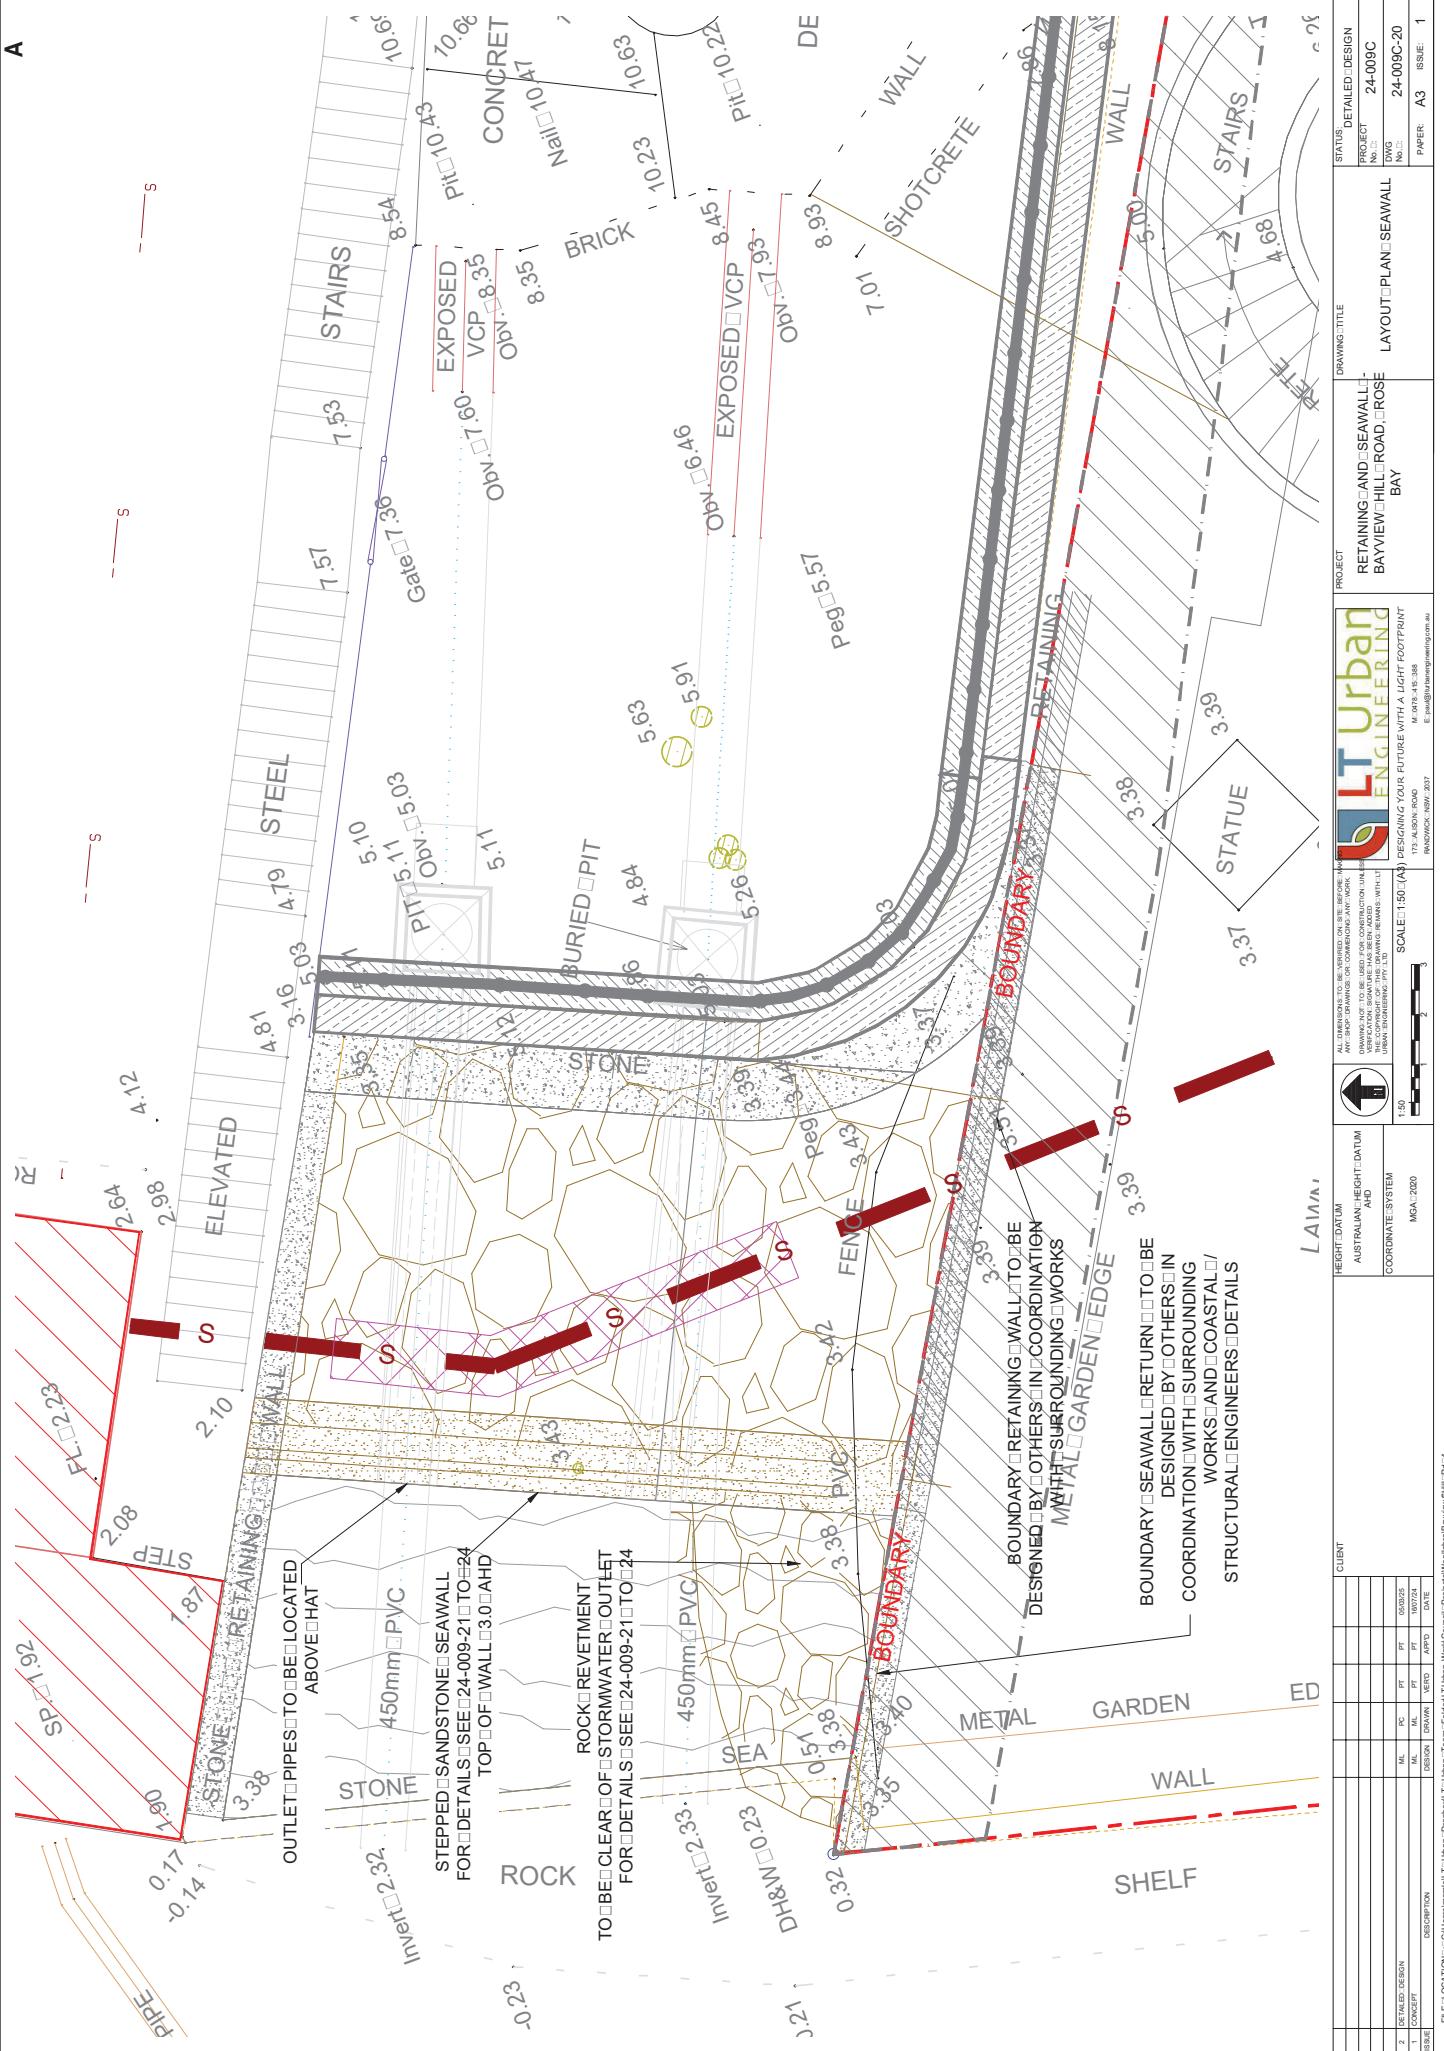

A

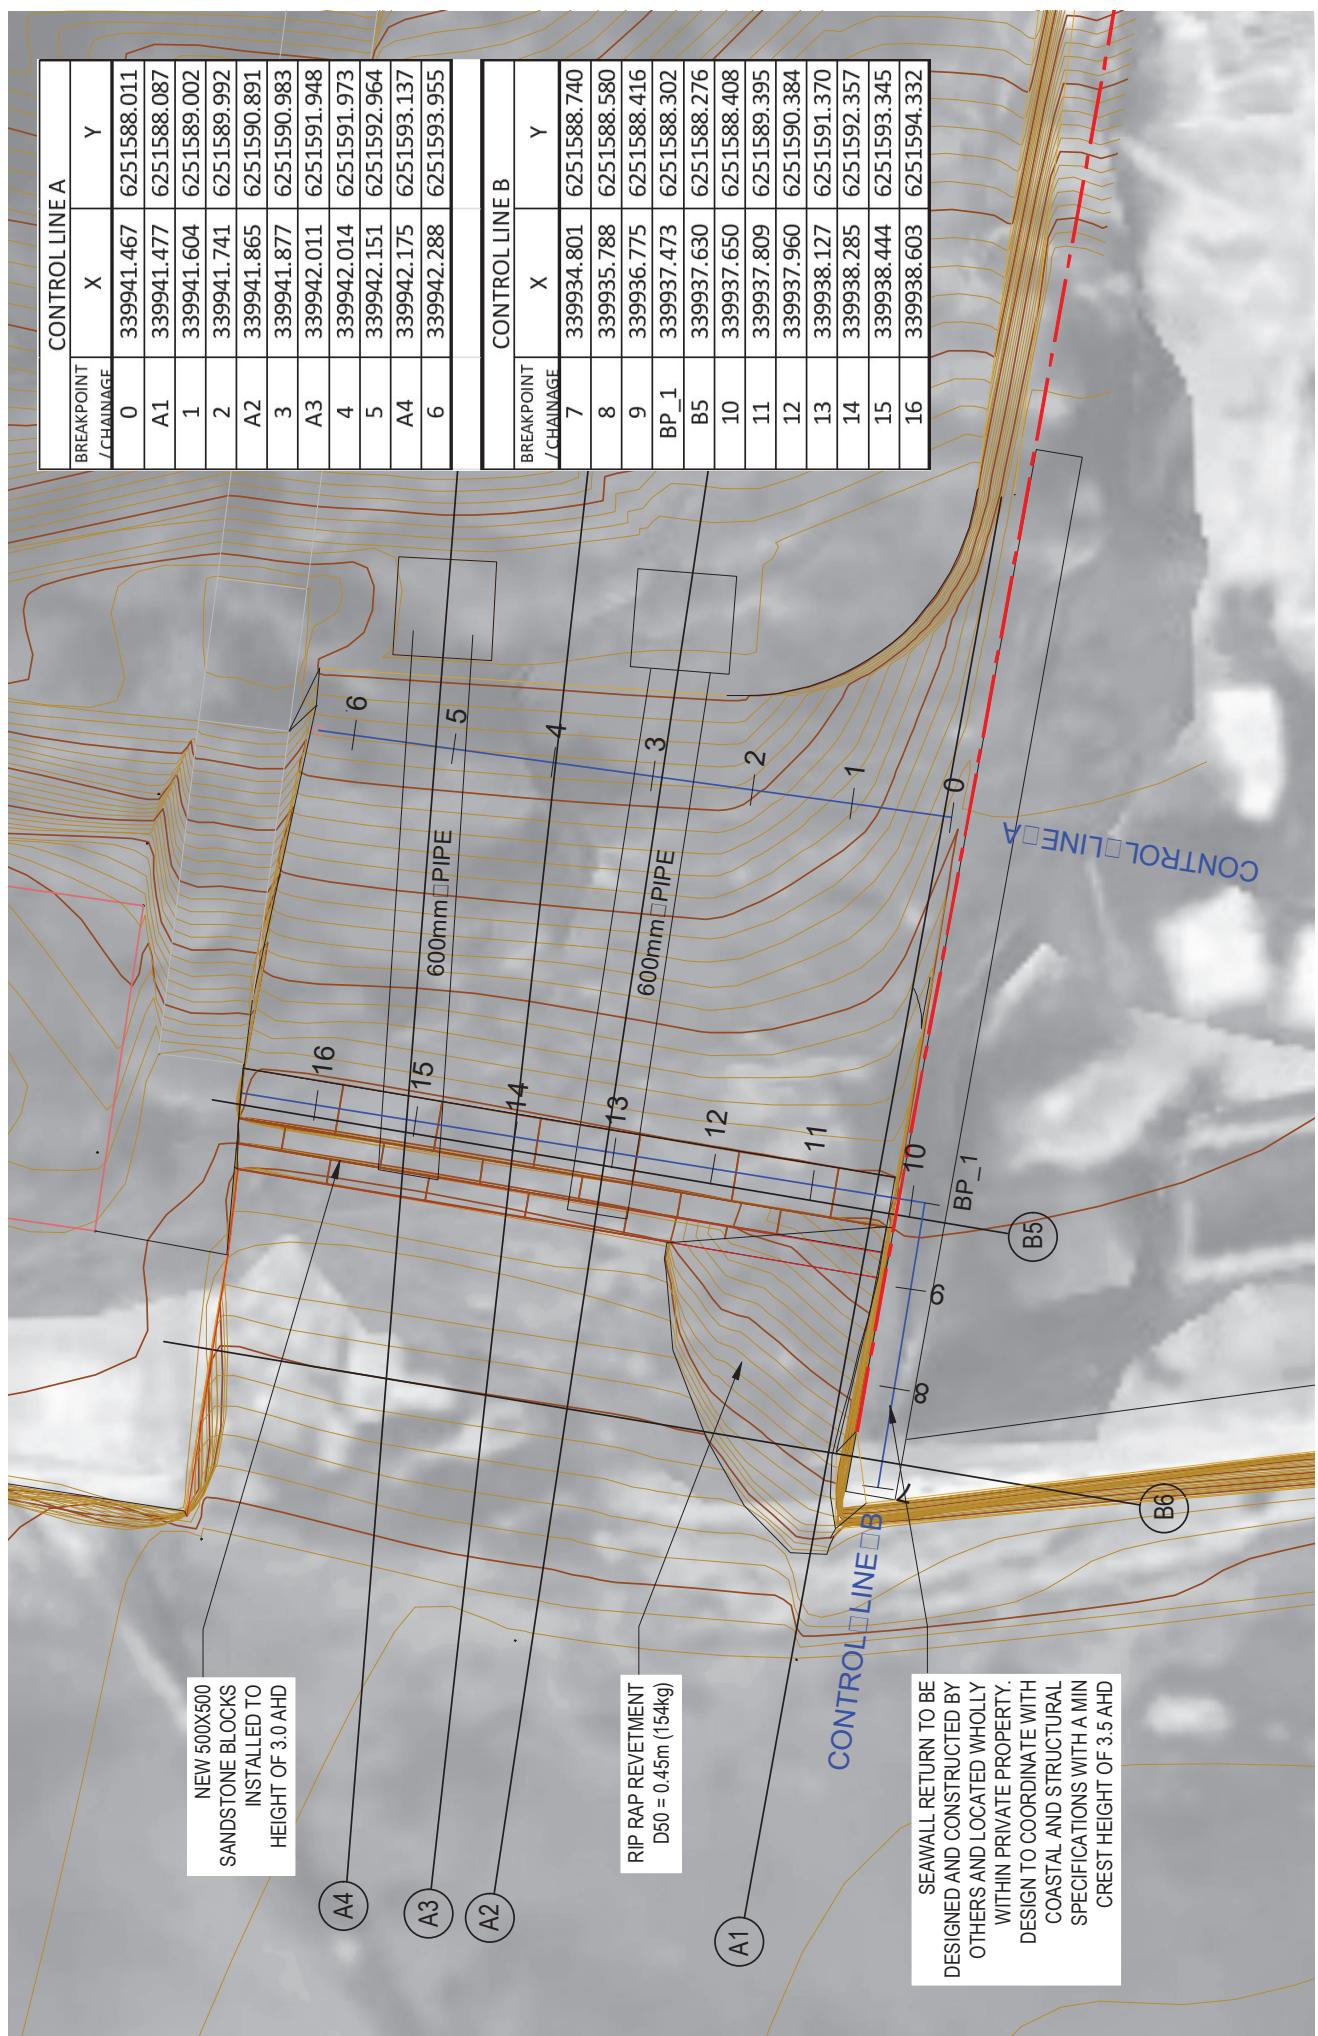

CLIENT	HEIGHT DATUM AND SEAWALL	DRAWING TITLE	STATUS: DETAILED DESIGN
	AUSTRALIAN HEIGHT DATUM	PROJECT	PROJECT: 24-009C
	COORDINATE SYSTEM	RETAINING AND SEAWALL	DWG No.: 24-009C-21
	NGA v.2020	BAYVIEW HILL ROAD, ROSE BAY	PAPER: A3
3 DETAILED DESIGN	PC	1:50	ISSUE: 2
2 CONCEPTUAL SECTION BE ADVISED	PC		
1 CONCEPT	PC		
TABLE	DETAIL		
DETAIL	DET		

A

REFER TO SEAWALL LAYOUT
PLAN (DWG 24-009C-21) FOR
A1-A4 SECTIONS LOCATION

400MM □ RETAINING □ WALL □ BEHIND EXISTING □ RETAINING □ WALL □ TO STRUCTURAL □ ENGINEERS

5.10 AHD

SEAWALL RETURN TO BE DESIGNED AND CONSTRUCTED BY OTHERS AND LOCATED WITHIN PRIVATE PROPERTY.
DESIGN TO COORDINATE WITH COASTAL AND STRUCTURAL SPECIFICATIONS WITH A MIN CREST HEIGHT OF 3.5

A1

500X500 SANDSTONE -
KS INSTALLED TO
HT OF 3.0 AHD

100 YEAR WATER LEVEL (ESTIMATED LINE)

AFREVENTIEN
0.45m (154kg)

MSL 0.03 AHD

MSL 0.03 AHD

A2

200

100 YEAR WATER LEVEL 2.15 AHD
(ESTIMATED LEVEL)

LEVEL 2.15 AHD

HAT 1.18 AHD

HAT 1.18 AHD

MSL 0.03 AHD

MSL 0.03 AHD

LAT -0.93 AHD

LAT -0.93 AHD

CURVED SECTION OF
EXISTING RETAINING WALL

The diagram illustrates a cross-section of a retaining wall. The wall is built with grey hexagonal blocks and features a vertical steel reinforcement bar. A green line indicates the top of the wall. A horizontal dimension line shows a height of 1.5H from the base to the top of the wall. A vertical dimension line shows a thickness of 600mm for the square pipe reinforcement. In the upper right corner, there is a callout box with the title "NOTES - GENERAL". Inside the box, the following text is written:

THE RATIO OF THE MAXIMUM DIMENSION OF ROCK TO THE MINIMUM DIMENSION MEASURED AT RIGHT ANGLES TO THE MAXIMUM DIMENSION SHALL NOT EXCEED 2.5

2.	REFER TO TECHNICAL SPECIFICATIONS
3. DETAILS REFERRING TO GRANULAR FILL	
	SIEVE SIZE (mm)
	% PASSING
	100
150	
75	70-100
37.5	30-50
9.5	15-35
2	0-20
0.6	0-10
0.075	0-5

NEW GRANULAR FILL TO BE
INSTALLED TO 300mm BELOW
FINISHED SURFACE AND
ENCLOSED WITH
SEOTEXTILE FABRIC

ONTROL LINE A

ENTIRE WALL MUST BE NOTED

PROJECT	DRAWING/TITLE	STATUS/DETAILED DESIGN	PROJ./EGT	24-009C
REF.	NO.	REV.	NO.	24-009C-22
RETAINING AND SEAWALL BAYVIEW/HILL ROAD ROSE BAY	SEAWALL SECTION-01			
LT Urban Engineering	DESIGN DRAWINGS FOR THE LIGHT FOOTPRINT	PAPER: A3	SSQE:	
	M.A.T. 15-360 E: info@lturbanengineering.com.au			

1

NEW HOT DIPPED GALVANISED BALUSTRADE WITH OFFSET HANDRAIL "CONNECTABAL CB45" BY "MODDEX" OR EQUIVALENT TO BE INSTALLED TO MEET THE BCA REQUIREMENTS AND COMPLY WITH AS 1170 AND STRUCTURAL ENGINEERS DETAILS.

REVERTMENT BETWEEN STEPPED SEAWALL AND EXISTING
RETAINING WALL TO COASTAL ENGINEERING SPECIFICATIONS.
MATCH LEVELS WITH SURROUNDING WALLS. MAX. GRADE 1V:1.5H

NOTES - GENERAL																	
THE RATIO OF THE MAXIMUM DIMENSION OF ANY ROCK TO THE MINIMUM DIMENSION MEASURED AT RIGHT ANGLES TO THE MAXIMUM DIMENSION SHALL NOT EXCEED 2.5																	
1.	REFER TO TECHNICAL SPECIFICATIONS																
2.	3. DETAILS REFERRING TO GRANULAR FILL:																
	<table border="1"> <thead> <tr> <th>SIEVE SIZE (mm)</th> <th>% PASSING</th> </tr> </thead> <tbody> <tr> <td>150</td> <td>100</td> </tr> <tr> <td>75</td> <td>70-100</td> </tr> <tr> <td>37.5</td> <td>30-50</td> </tr> <tr> <td>9.5</td> <td>15-35</td> </tr> <tr> <td>2</td> <td>0-20</td> </tr> <tr> <td>0.6</td> <td>0-10</td> </tr> <tr> <td>0.075</td> <td>0-5</td> </tr> </tbody> </table>	SIEVE SIZE (mm)	% PASSING	150	100	75	70-100	37.5	30-50	9.5	15-35	2	0-20	0.6	0-10	0.075	0-5
SIEVE SIZE (mm)	% PASSING																
150	100																
75	70-100																
37.5	30-50																
9.5	15-35																
2	0-20																
0.6	0-10																
0.075	0-5																

NEW HOT DIPPED GALVANISED BALUSTRADE WITH OFFSET HANDRAIL "CONNECTABAL CB45" BY "MODDEX" OR EQUIVALENT TO BE INSTALLED TO MEET THE BCA REQUIREMENTS AND COMPLY WITH AS 1170 AND STRUCTURAL ENGINEERS DETAILS.

RETAINING WALL BEHIND EXISTING RETAINING STRUCTURAL ENGINEERS DETAILS — CURVED SECTION OF EXISTING RETAINING WALL

SEAWALL RETURN TO BE DESIGNED AND
CONSTRUCTED BY OTHERS AND LOCATED
WHOLLY WITHIN PRIVATE PROPERTY.
DESIGN TO COORDINATE WITH COASTAL
AND STRUCTURAL SPECIFICATIONS WITH A
MIN CREST HEIGHT OF 3.5 AHD

NOTES

WHERE BASEMENT ROCK IS NOT
ENCOUNTERED WITHIN 300mm OF THE
EXISTING SURFACE PROFILE INSTALL
GRANULAR BEDDING ENCLOSED WITH
GEOTEXTILE . FOR LOCATIONS WHERE
BASEMENT ROCK IS ENCOUNTERED
PROFILE AND SHAPE IN SITU ROCK
TO MAXIMISE CONTACT BETWEEN
THE LOWER BLOCK AND THE ROCK
BEDDING, INSTALL MORTAR BEDDING
AS REQUIRED TO ACHIEVE A
CONTINUOUS AND LEVEL SURFACE
FOR BLOCK PLACEMENT.


CONTROL LINE B

SEAWALL BASE SEE NOTES

LAT -0.93 AHD


RIP RAP REVETMENT
 $D_{50} = 0.45\text{m}$ (154kg)

A

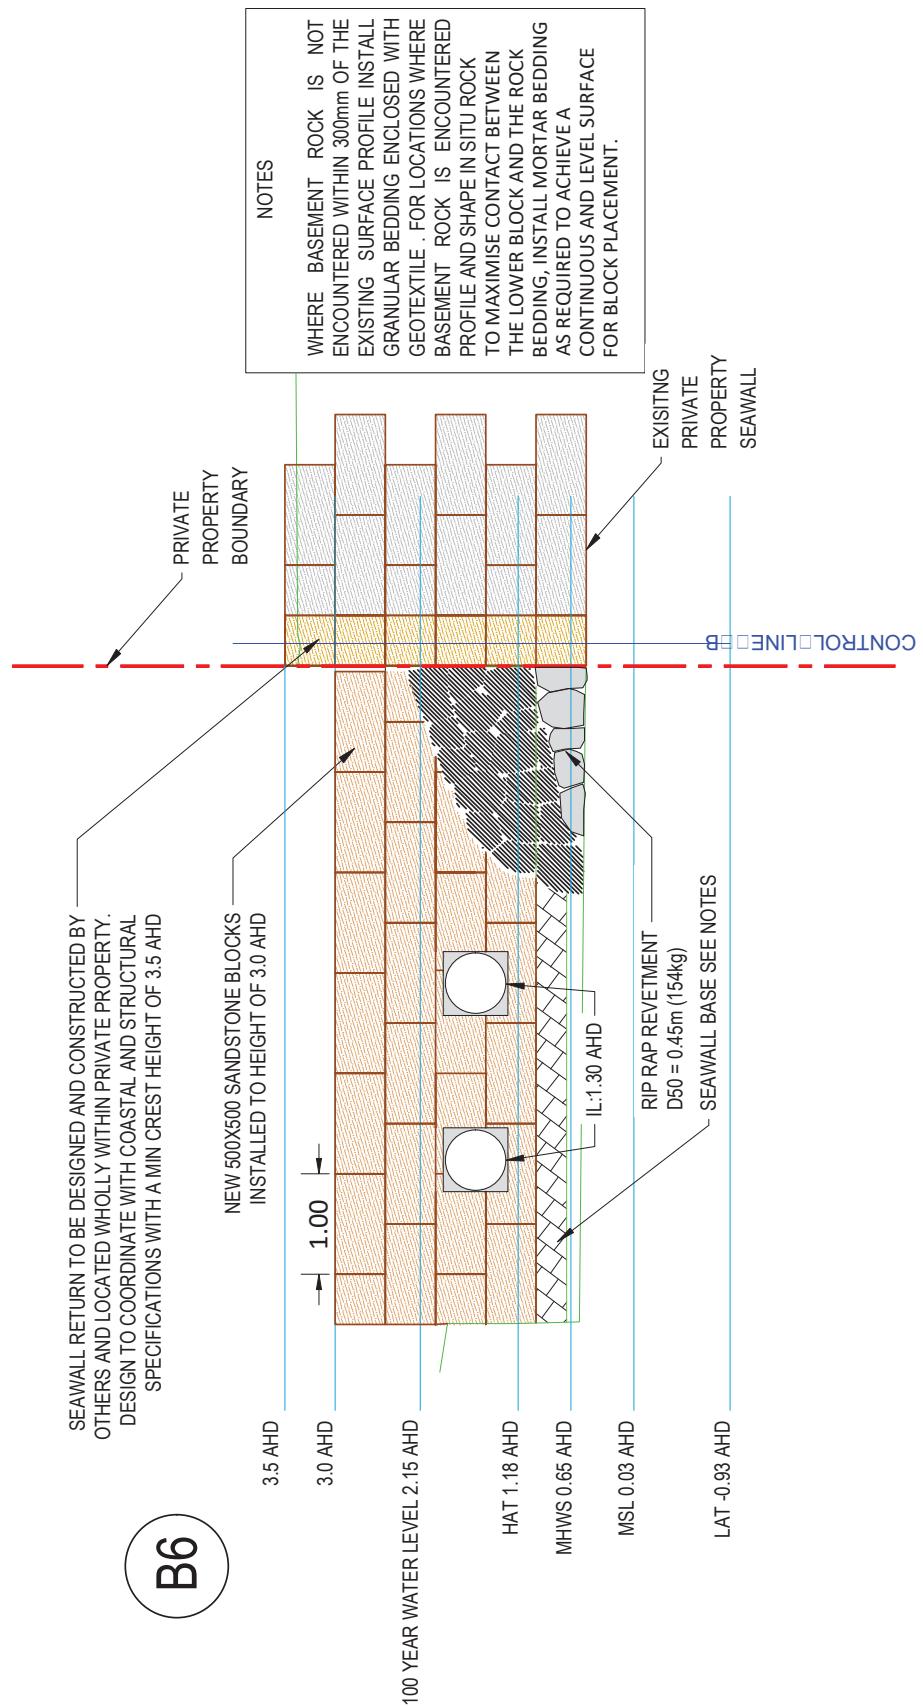


FILE LOCATION : C:\Users\immo\T_Urban\Dropbox\T_Urban\Team\Folder\T_Urban\Project\Walls\B6\B6.dwg		PROJECT : RETAINING AND SEAWALL - BAYVIEW HILL ROAD, ROSE BAY		DRAWING TITLE : SEAWALL SECTION-04		STATUS : DETAILED DESIGN	
FILE NUMBER : 24-009C		DESIGNER : DWG		DRAWN BY : 24-009C-25		REVIEWED BY : A3	
CONTRACT NUMBER : A3		DATE : 06/07/2017		PAPER : 2		ISSUE : 2	
DETAILED DESIGN		DRAWN : 06/07/2017		CHECKED : 06/07/2017		APPROVED : 06/07/2017	
CONCEPT DESIGN		DRAWN : 06/07/2017		CHECKED : 06/07/2017		APPROVED : 06/07/2017	
DETAILS		DRAWN : 06/07/2017		CHECKED : 06/07/2017		APPROVED : 06/07/2017	
DESIGNATION : B6		SCALE : 1:50 (A4)		FILE NUMBER : 24-009C		DRAWN : 06/07/2017	
CLIENT :		HEIGHT DATUM : AUSLANT HEIGHT - DATUM AHD		DRAWING NUMBER : 24-009C		DRAWN : 06/07/2017	
DESIGNER : LT Urban ENGINEERING		COORDINATE SYSTEM : MGA - 2000		CHECKED : 06/07/2017		APPROVED : 06/07/2017	
DRAWN : 06/07/2017		CHECKED : 06/07/2017		APPROVED : 06/07/2017		FILE NUMBER : 24-009C	
DESIGNER : LT Urban ENGINEERING		DRAWN : 06/07/2017		CHECKED : 06/07/2017		APPROVED : 06/07/2017	
DRAWN : 06/07/2017		CHECKED : 06/07/2017		APPROVED : 06/07/2017		FILE NUMBER : 24-009C	
DRAWN : 06/07/2017		CHECKED : 06/07/2017		APPROVED : 06/07/2017		FILE NUMBER : 24-009C	
A

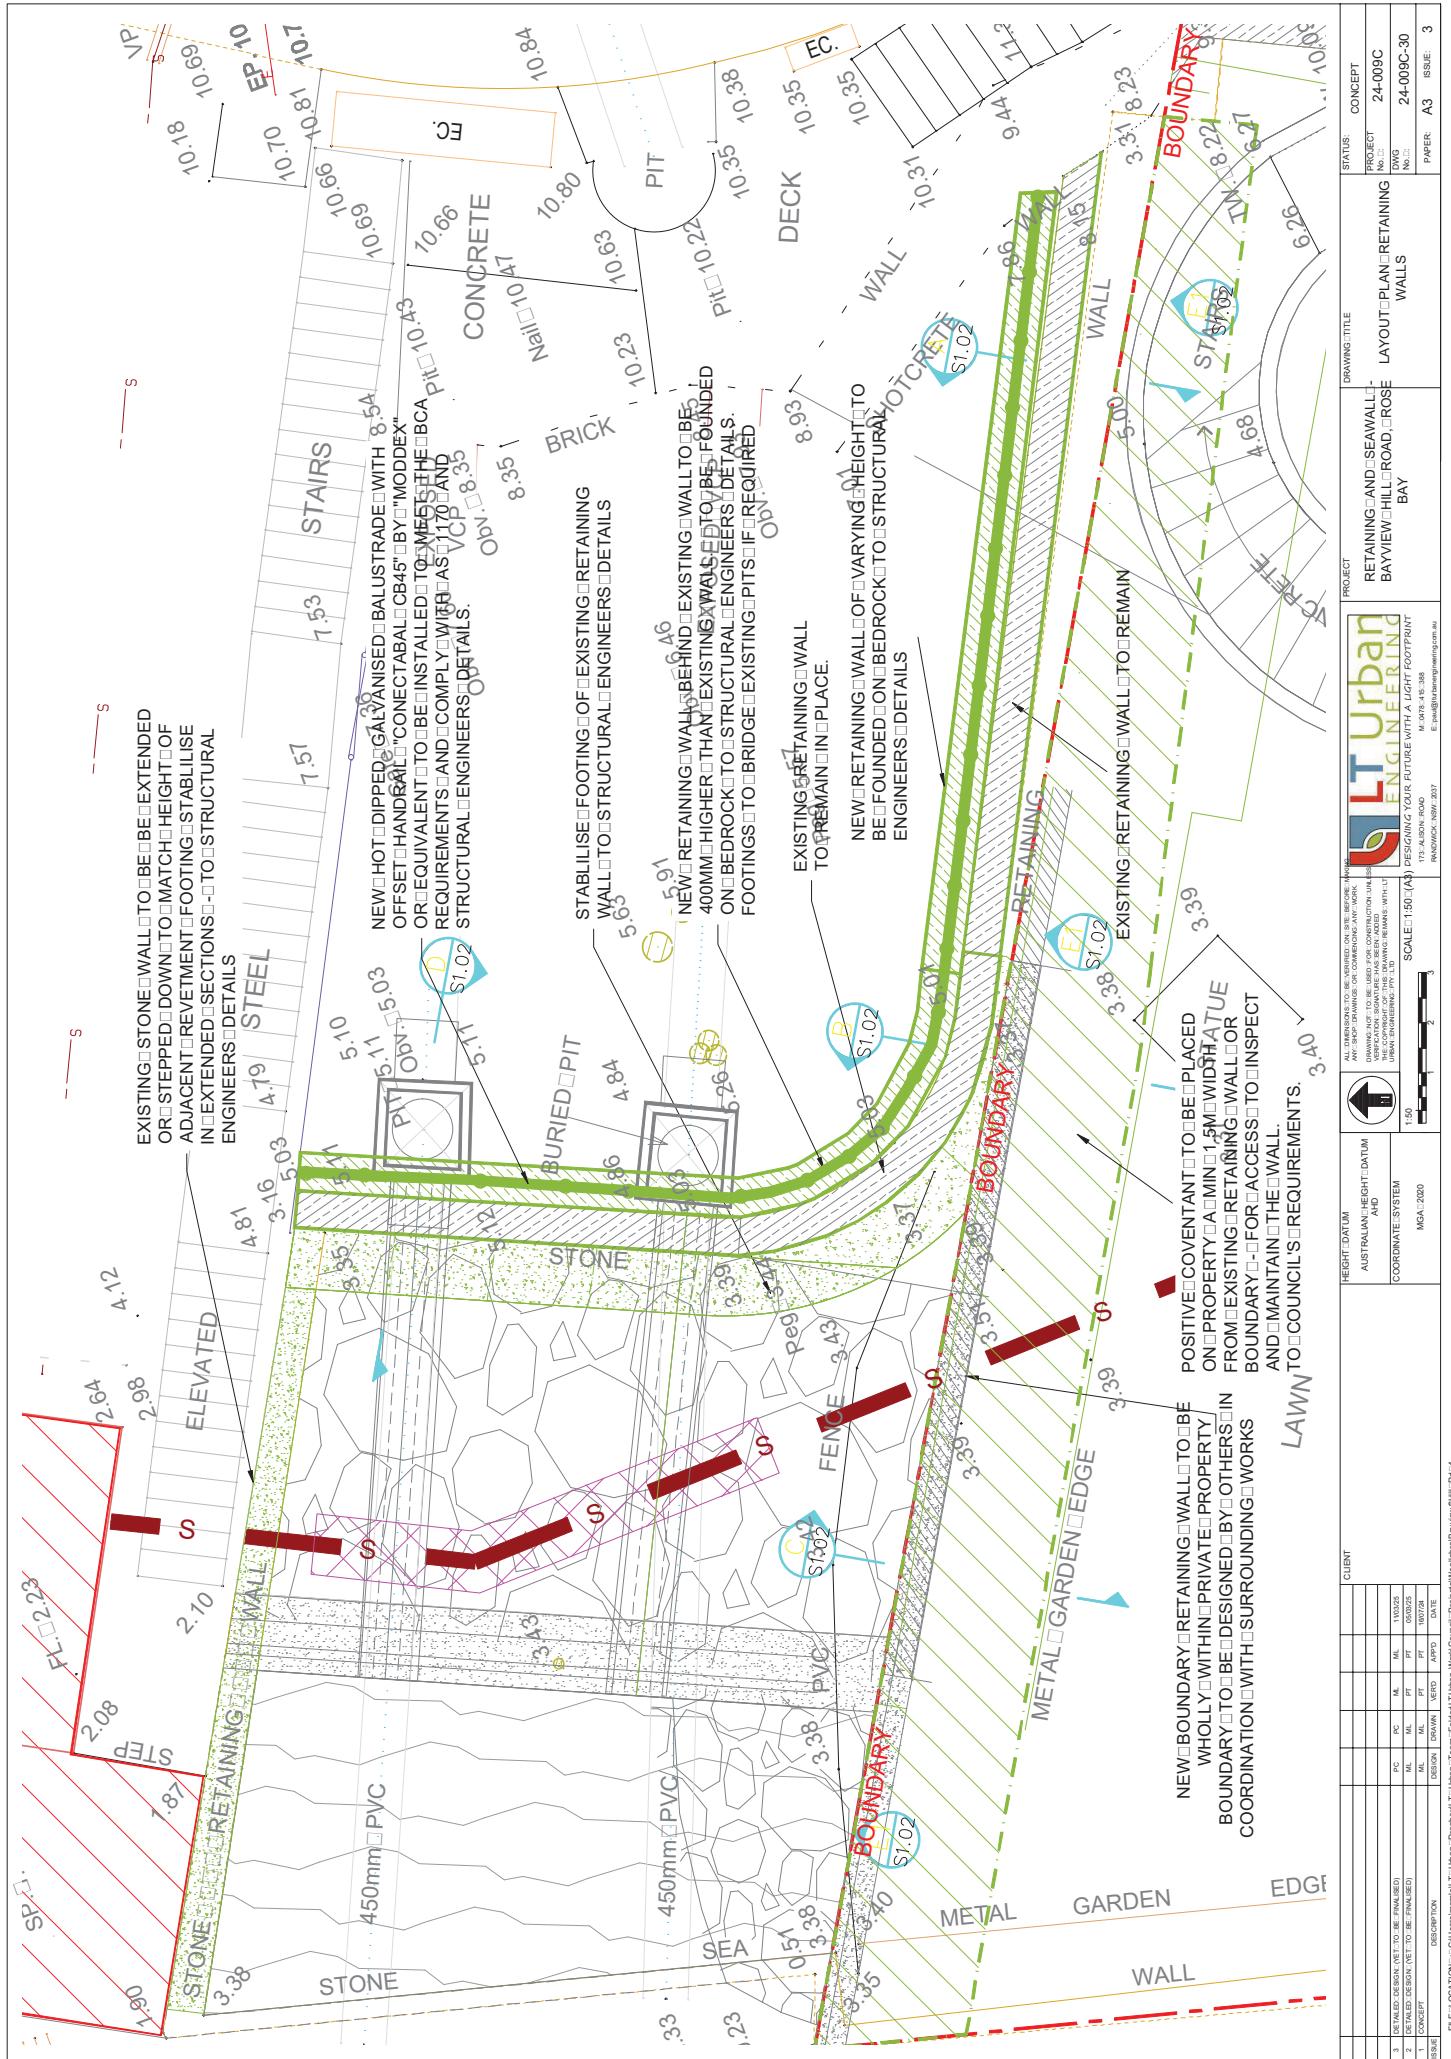

A



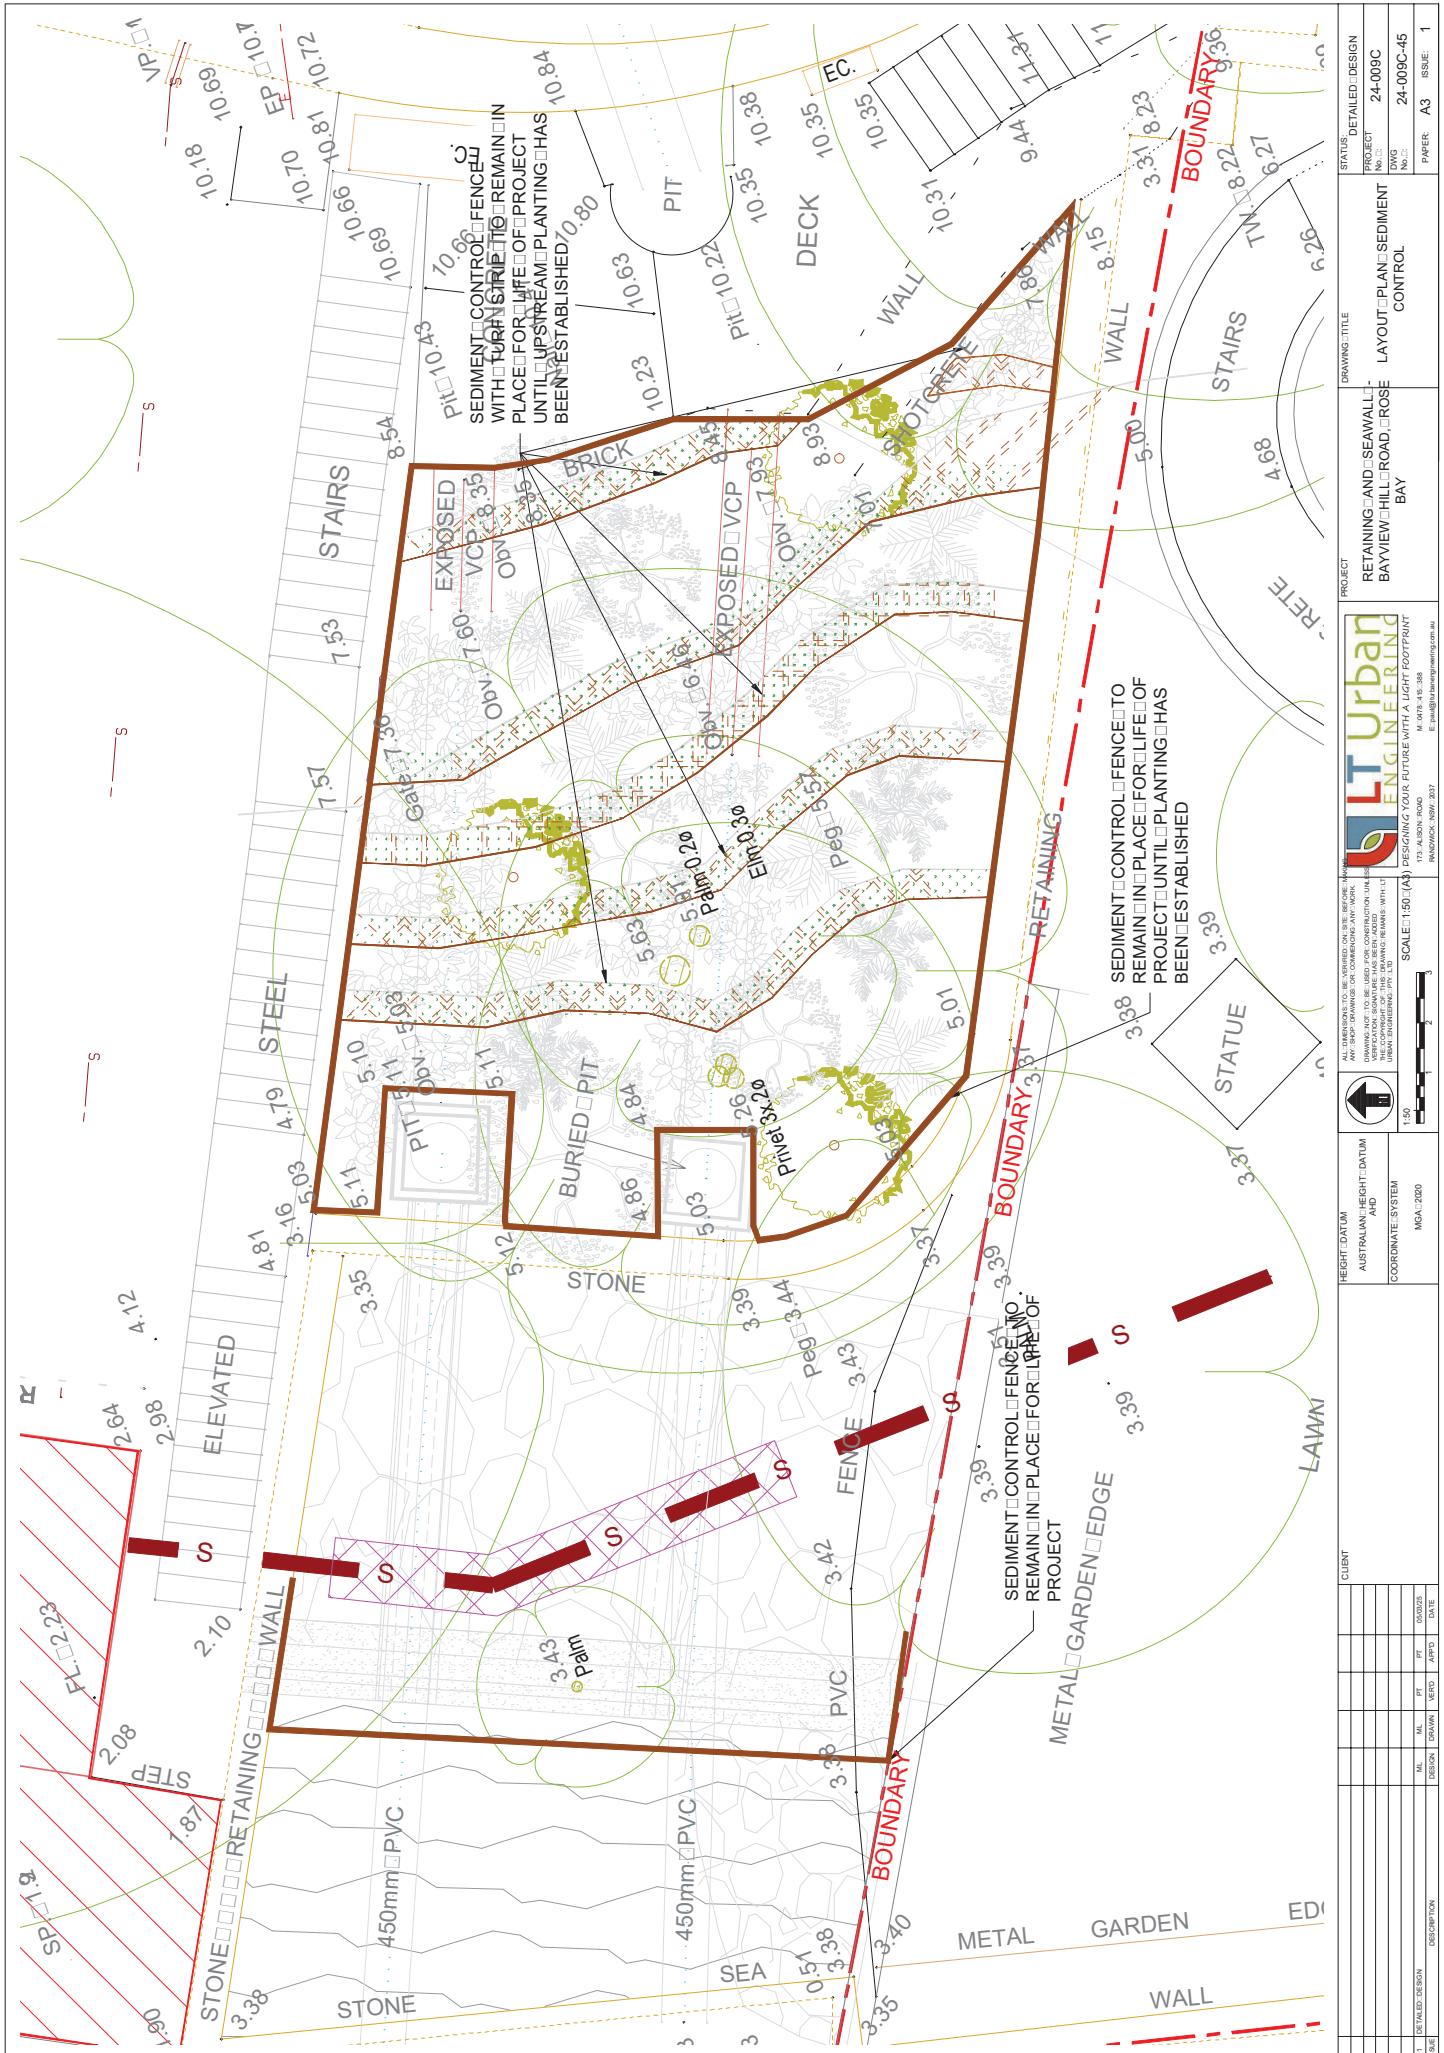

FILE ■ LOCATION : □ C:\Users\Imran\LT\Urban\Dropbox\LT\Urban\Team\FoldenLT\Urban-Work\Council\Projects\Woolahra Bay view 61\ ■ Rd 4-

EROSION AND SEDIMENT CONTROL

1. GENERAL MEASURES

STOPPILES SHALL BE CONFINED TO ONE CENTRAL AREA WHERE POSSIBLE, TO IN PLACE EROSION CONTROL MEASURES. ALL CONSTRUCTION CONCERNED MEASURES ARE APPLIED PROTECT ADJOINING PROPERTIES FROM EROSION AND SILT DAMAGE. EROSION CONTROL MEASURES NOT TO BE REMOVED UNTIL CONSTRUCTION IS COMPLETED AND SITE HAS BEEN REHABILITATED. REHABILITATION INCLUDES COMPLETION OF ALL CONSTRUCTION WORK AND LANDSCAPING, SEEDING OR TURFING OF ALL BATTERS, AND FILL AREAS INSTALLED AND CONNECTED AS EARLY AS POSSIBLE.

ALL AREAS NOT SUBJECT TO CONSTRUCTION WORKS SHALL BE RETAINED FREE FROM DISTURBANCE OR DAMAGE DURING THE LIFE OF THE CONTRACT. SHOULD THESE AREAS BECOME DISTURBED OR DAMAGED, THEY SHALL BE RESTORED BY THE CONTRACTOR AT NO COST TO THE PRINCIPAL.

PIPE DRAINAGE NETWORKS SHOULD BE INSTALLED AND CONNECTED AS EARLY AS POSSIBLE.

STABILISATION OF DISTURBED AREAS SHALL BE IN ACCORDANCE WITH COUNCILS SPECIFICATION FOR GRASSING AND/OR SPECIFICATION FOR LANDSCAPE WORKS. THE FOLLOWING SHALL BE APPLIED FOR THE CONTROL OF EROSION AND SEDIMENTATION:

- STABILISATION OF DENUDED AREAS SHALL COMMENCE AS SOON AS POSSIBLE AFTER THE AREAS HAVE BEEN DISTURBED. ALL STABILISATION MEASURES SHALL BE UNDERTAKEN PRIOR TO THE END OF THE MAINTENANCE PERIOD.

2. STABILISATION OF DISTURBED AREAS

STABILISATION OF DISTURBED AREAS SHALL BE IN ACCORDANCE WITH COUNCILS SPECIFICATION FOR GRASSING AND/OR SPECIFICATION FOR LANDSCAPE WORKS. THE FOLLOWING SHALL BE APPLIED FOR THE CONTROL OF EROSION AND SEDIMENTATION:

- STABILISATION OF DENUDED AREAS SHALL COMMENCE AS SOON AS POSSIBLE AFTER THE AREAS HAVE BEEN DISTURBED. ALL STABILISATION MEASURES SHALL BE UNDERTAKEN PRIOR TO THE END OF THE MAINTENANCE PERIOD.

3. MAINTENANCE


ALL SEDIMENT AND EROSION CONTROL DEVICES SHALL BE MAINTAINED IN A SATISFACTORY WORKING ORDER THROUGHOUT THE CONTRACT. MAINTENANCE AND DEFECTS LIABILITY PERIODS OR UNTIL SUCH EARLIER TIME AS THE PRINCIPAL HAS STABILISED AND THE SUPERINTENDENT DIRECTS THE CONTRACTOR SHALL INSPECT ALL DEVICES AFTER EACH STORM FOR STRUCTURAL DAMAGE OR BLOCKAGES BY SEDIMENT AND OTHER DEBRIS AND MAKE REPAIRS OR REPLACEMENT AS SOON AS PRACTICABLE.

4. SEDIMENT CONTROL DEVICES (S.C.D.)

THESE SHALL BE CONSTRUCTED AT INLETS TO STORMWATER SYSTEMS TO TRAP THE SEDIMENT IN N.M.F. SECTION 11.3.20/04/06 OF THE NSW DEPARTMENT OF HOUSING CONSTRUCTION SPECIFICATION, 1989 EDITION, SHALL APPLY.


NOTES:

- IN UNDERTAKING TRENCH EXCAVATION, THE CONTRACTOR SHALL PROVIDE ANY SHORING, SHEET PILING OR OTHER STABILISATION REQUIREMENTS. THE SIDE SHALL NOT BE LADED & SHALL BE KEPT CLEAR OF LOOSE MATERIAL, ETC. SAFE ACCESS & EGRESS SHALL BE PROVIDED AT ALL TIMES.
- THE TRENCH SHALL BE EXCAVATED TO A WIDTH 1.4 TIMES THE EXTERNAL DIAMETER OF THE PIPE, OR TO THE EXTERNAL DIAMETER OF THE PIPE PLUS 300mm ON EACH SIDE, WHICHEVER IS THE GREATER.
- ALL WORKS SHALL BE CONDUCTED IN A SAFE MANNER WITH THE LEAST POSSIBLE OBSTRUCTION TO BOTH VEHICULAR, PEDESTRIAN TRAFFIC, ATRAFFIC, CONTROL PLANT SHALL BE SUBMITTED TO COUNCIL INDICATING ALL ACTIVITIES FOR CONSTRUCTION, CAR PARKING, ETC. IN THE EXISTING ENVIRONMENT. IN ACCORDANCE WITH AS702.3 AND OTHER REQUIREMENTS OF THE RELEVANT STATUTORY AUTHORITIES.
- THE CONTRACTOR SHALL ENSURE THAT ALL NECESSARY SEDIMENT CONTROL MEASURES ARE PROVIDED IN ACCORDANCE WITH THE REQUIREMENTS OF THE RELEVANT STATUTORY AUTHORITIES. ALL SEDIMENT & EROSION CONTROL MEASURES SHALL BE MAINTAINED THROUGHOUT THE PERIOD OF WORKS, INCLUDING REPAIR AND/OR REPLACEMENT OF DAMAGED SECTIONS. INSPECTIONS SHALL BE MADE PERIODICALLY AND, AFTER STORM EVENTS FOR DAMAGE.
- ALL LINEMARKING & SIGNPOSTING AFFECTED BY WORKS SHALL BE REINSTATED IN ACCORDANCE WITH AS 1342 & THE RMS SPECIFICATIONS.
- ALL DIMENSIONS ARE IN MILLIMETRES UNLESS OTHERWISE SHOWN.

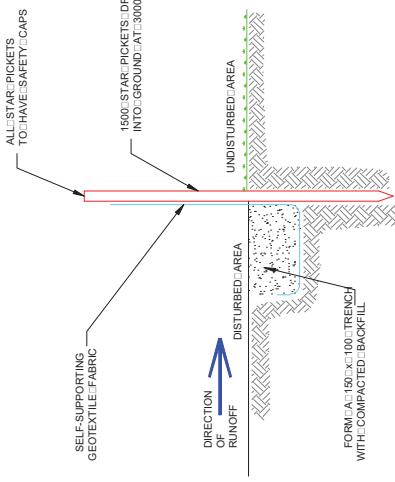


SECTION THROUGH STAR PICKET AND SEDIMENT FENCE DETAIL

N.T.S.

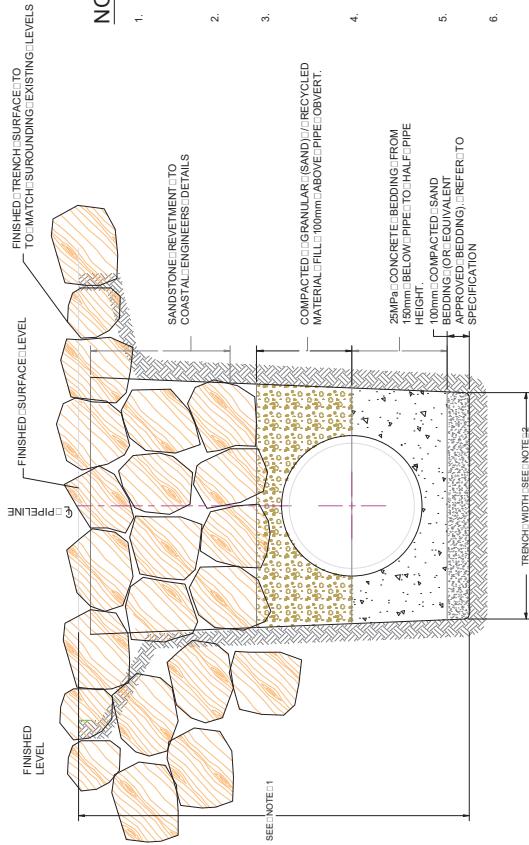

TYPICAL SECTION PIPELINE BACKFILL

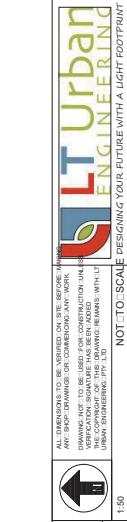

FILE LOCATION	MARK DATE	DRAWING NUMBER	CUSTOMER	PROJECT	RETAINING AND SEAWALL BAYVIEW HILL ROAD, ROSE BAY	DRAWING TITLE	DRAWING NUMBER	DRAWING STATUS	DETAILED DESIGN
C:\Users\mylearn\Urban\Dropbox\Urban Team-Folder\Urban-Team	10/07/2011	LT Urban Engineering		LT Urban	Engineering	NOT TO SCALE DESIGN YOUR FUTURE WITH A LIGHT FOOTPRINT	24-009C	24-009C	24-009C-50
							173	4/4-368	A3

FILLE LOCATION : C:\Users\mylearn\Urban\Dropbox\Urban Team-Folder\Urban-Team\Project\Wordraft@btv@y.com.au\Rd-A4.dwg
FILE MARK DATE : 10/07/2011
FILE DRAWING NUMBER : 24-009C
FILE CUSTOMER : LT Urban Engineering
FILE PROJECT : Engineering

